

FINLAYSON BONET ARCHITECTURE LTD.

#4 - 7855 East Saanich Rd.

Saanichton V8M 2B4

Phone: 250-656-2224 Fax. 250-656-2279 Email: info@finlaysonbonet.ca

1 24Jan24 Revised as noted

24Nov23 Issued for Variance 25Aug23 B.P. Revisions

27July23 B.P. Revisions

15Jun23 Issued for B.P.

JANUARY 24, 2024

RESTHAVEN DRIVE

NEW DUPLEX

10214 RESTHAVEN DRIVE,

SIDNEY, B.C.

Description

SMB/AV


BEH / RJC

AS NOTED

Rev Date

Checked By

Drawing Title

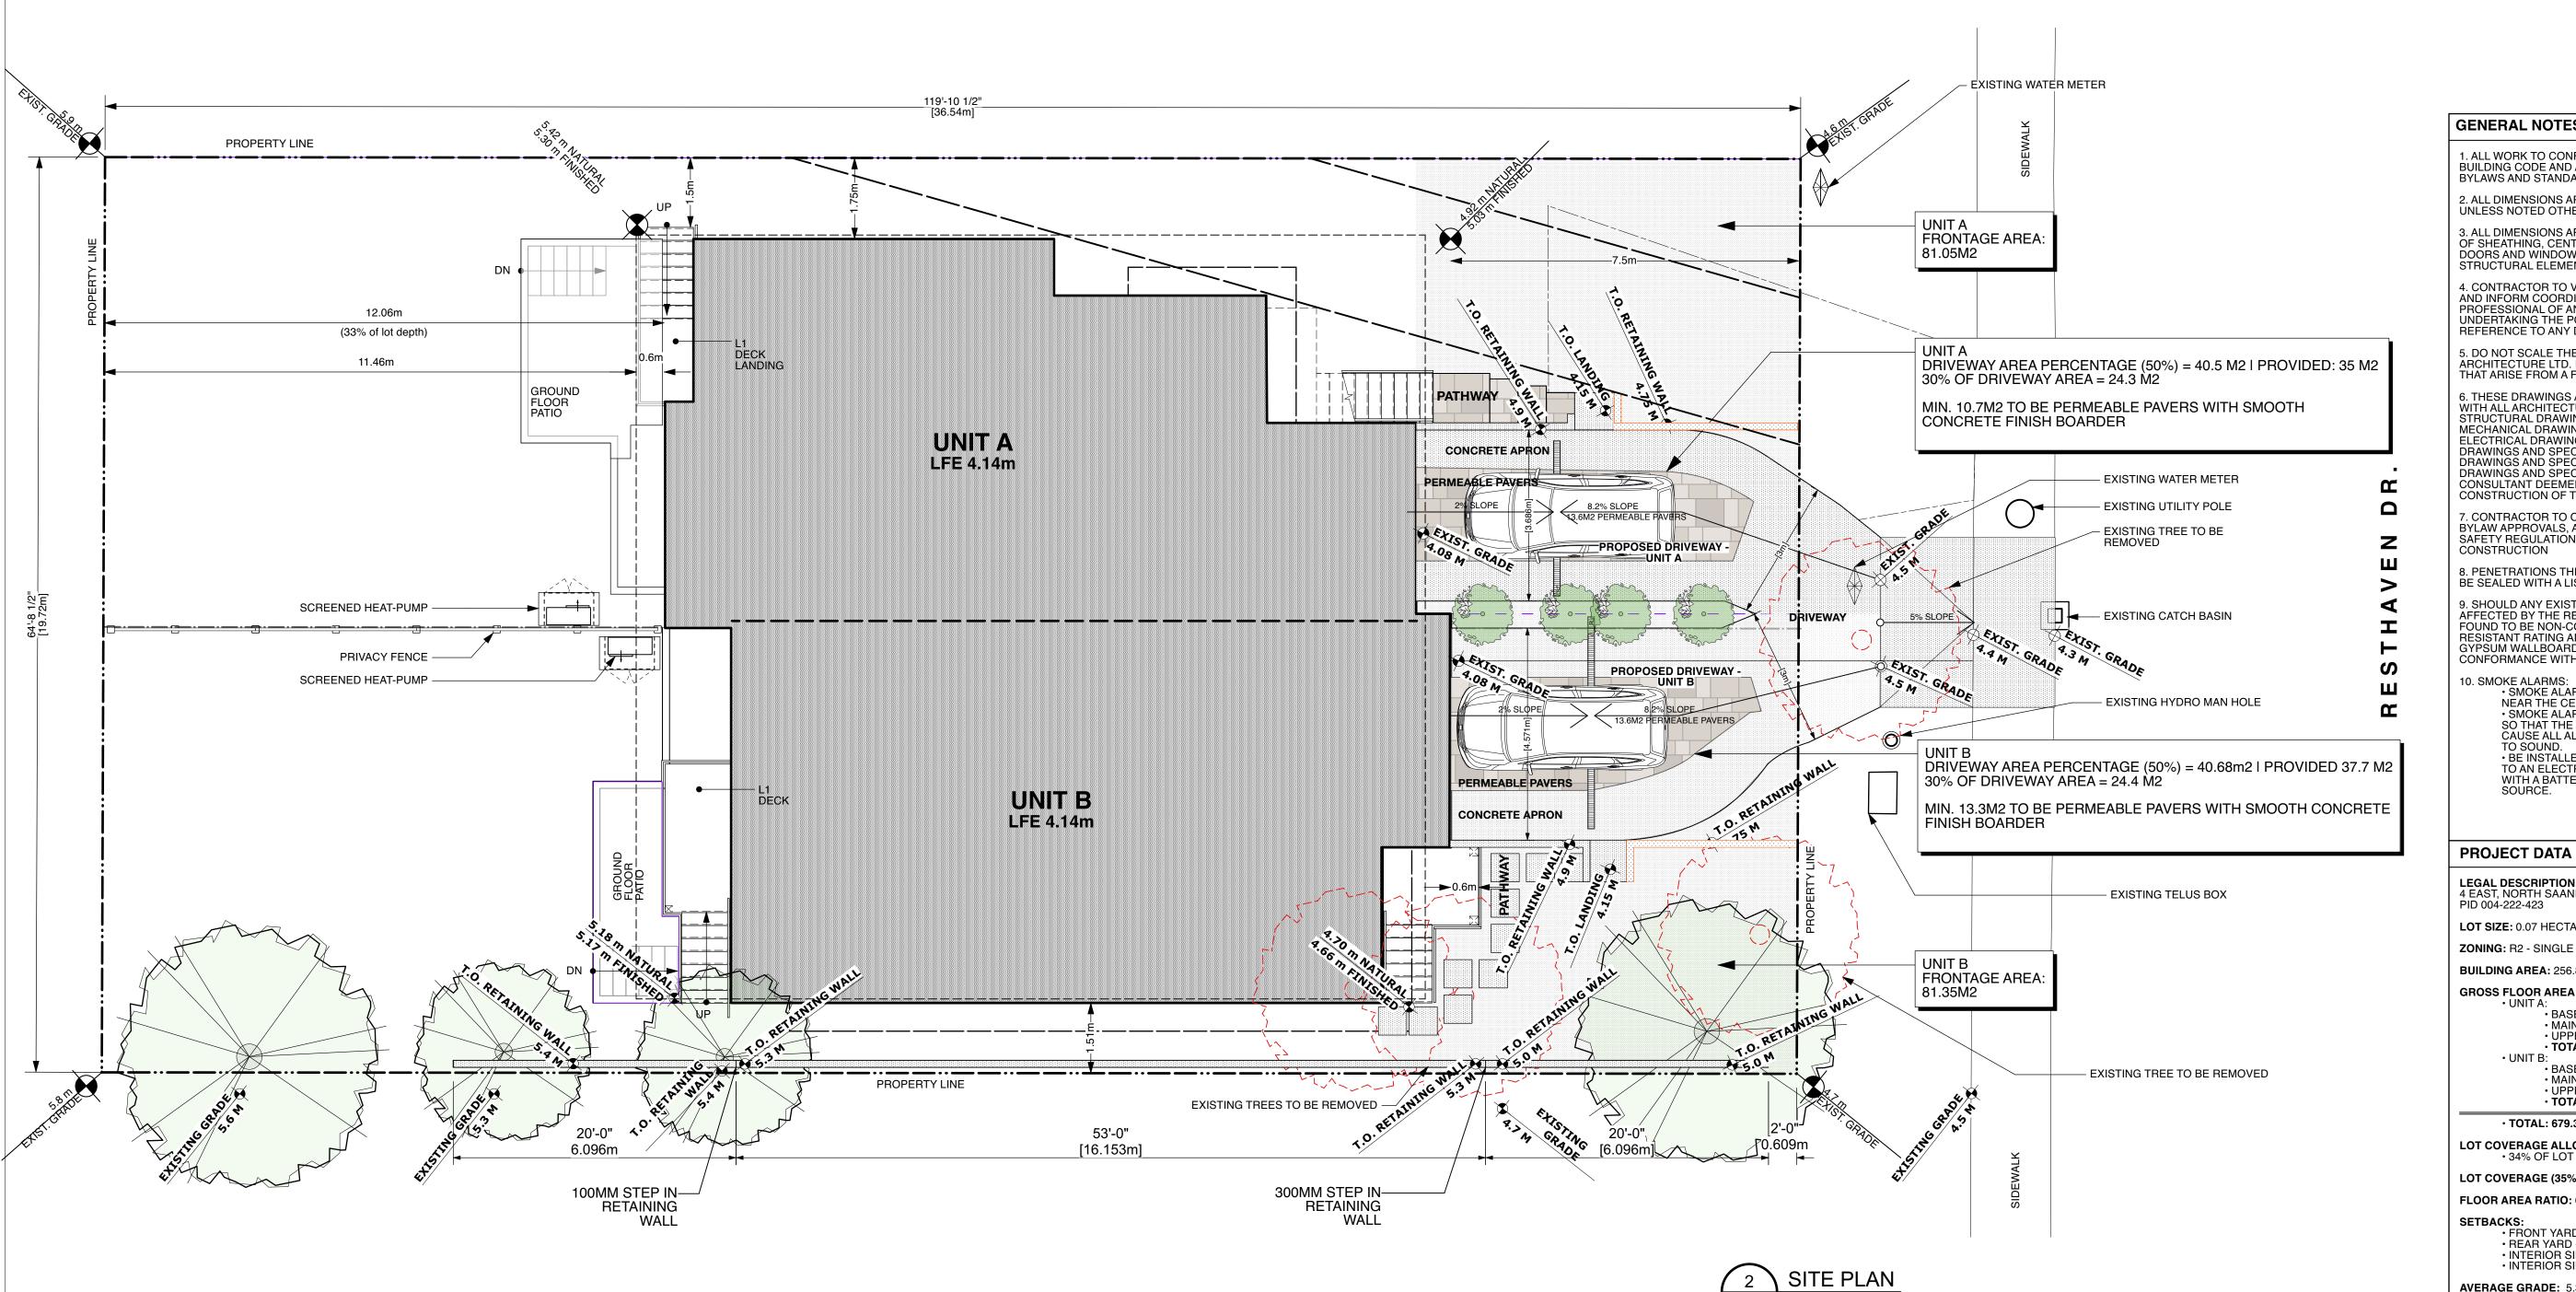

GENERAL NOTES

1. ALL WORK TO CONFORM TO 2018 BRITISH COLUMBIA BUILDING CODE AND ALL OTHER APPLICABLE CODES, BYLAWS AND STANDARDS.

2. ALL DIMENSIONS ARE IN IMPERIAL (FEET & INCHES) UNLESS NOTED OTHERWISE.

3. ALL DIMENSIONS ARE TO FACE OF CONCRETE, FACE OF SHEATHING, CENTERLINE OF STUD, CENTERLINE OF DOORS AND WINDOWS, AND TO FACE OF ANY OTHER STRUCTURAL ELEMENT NOT LISTED.

4. CONTRACTOR TO VERIFY ALL DIMENSIONS ON SITE AND INFORM COORDINATING REGISTERED PROFESSIONAL OF ANY DISCREPANCIES PRIOR TO UNDERTAKING THE PORTION OF WORK WHICH IS IN REFERENCE TO ANY DISCREPANCY.

5. DO NOT SCALE THESE DRAWINGS. FINLAYSON BONET ARCHITECTURE LTD. IS NOT RESPONSIBLE FOR ISSUES THAT ARISE FROM A FAILURE TO COMPLY.

6. THESE DRAWINGS ARE TO BE READ IN CONJUNCTION WITH ALL ARCHITECTURAL SPECIFICATIONS, STRUCTURAL DRAWINGS AND SPECIFICATIONS MECHANICAL DRAWINGS AND SPECIFICATIONS. ELECTRICAL DRAWINGS AND SPECIFICATIONS, CIVIL DRAWINGS AND SPECIFICATIONS, LANDSCAPE DRAWINGS AND SPECIFICATIONS, INTERIOR DESIGN DRAWINGS AND SPECIFICATIONS AND ANY OTHER CONSULTANT DEEMED PERTINENT TO THE CONSTRUCTION OF THIS PROJECT.

7. CONTRACTOR TO OBTAIN ALL NECESSARY PERMITS, BYLAW APPROVALS, AND OBSERVE ALL REQUIRED SAFETY REGULATIONS THROUGHOUT THE COURSE OF CONSTRUCTION

8. PENETRATIONS THROUGH FIRE SEPARATIONS ARE TO BE SEALED WITH A LISTED ULC FIRESTOP ASSEMBLY.

9. SHOULD ANY EXISTING FIRE RATED ASSEMBLY. AFFECTED BY THE RENOVATION SCOPE OF WORK, BE FOUND TO BE NON-COMPLIANT WITH A 45 MIN FIRE RESISTANT RATING ADDITIONAL LAYER(S) OF FIRE RATED GYPSUM WALLBOARD TO BE PROVIDED IN CONFORMANCE WITH BCBC 2018.

10. SMOKE ALARMS:
• SMOKE ALARMS SHALL BE INSTALLED ON OR NEAR THE CEILING.

 SMOKE ALARMS SHALL BE INTERCONNECTED SO THAT THE ACTUATION OF ONE ALARM WILL CAUSE ALL ALARMS WITHIN THE DWELLING UNIT BE INSTALLED WITH PERMANENT CONNECTIONS
TO AN ELECTRICAL CIRCUIT AND BE PROVIDED WITH A BATTERY AS AN ALTERNATIVE POWER

LEGAL DESCRIPTION: LOT 16, SECTION 14, RANGES 3 & 4 EAST, NORTH SAANICH DISTRICT, PLAN VIP15356, PID 004-222-423

LOT SIZE: 0.07 HECTARES / 0.18 ACRES / 719.6 m²

ZONING: R2 - SINGLE AND TWO-FAMILY RESIDENTIAL

BUILDING AREA: 256.86 m² **GROSS FLOOR AREA:**

• BASEMENT: 112.5 m² • MAIN FLOOR: 117.75 m² • UPPER FLOOR: 94.95 m² • TOTAL: 325.20 m²

• BASEMENT: 122.83 m² • BASEMENT. 122.03 III • MAIN FLOOR: 130.0 m² • UPPER FLOOR: 101.35 m² • TOTAL: 353.92 m²

• TOTAL: 679.38 m²

LOT COVERAGE ALLOWED:
• 34% OF LOT AREA ON MAIN FLOOR: 247.75 m² LOT COVERAGE (35% MAX): 35%

FLOOR AREA RATIO: 0.945 SETBACKS:

• FRONT YARD - EAST (7.50m): 7.50 m • REAR YARD - WEST (33%/12.00m): 12.06 m • INTERIOR SIDE YARD - NORTH (1.50): 1.5 m • INTERIOR SIDE YARD - SOUTH (1.50): 1.51 m

AVERAGE GRADE: 5.35 m - REFER TO FLOOD HAZARD

BUILDING HEIGHT: 9.29 m - VARIANCE REQUESTED AVERAGE NATURAL GRADE: 5.05M NUMBER OF STOREYS: 3 STOREYS

- VARIANCE REQUESTED

SITE PLAN & PROJECT DATA

Å1.00_{R1}

TRUSS ROOF ASSEMBLY - ATTIC INSULATION U-VALUE: 0.025U (R40.0) • 26ga STANDING SEAM METAL ROOFING - GALVALUME COLOUR • HIGH TEMPERATURE SYNTHETIC SELF ADHERED UNDERLAY • PLYWOOD SHEATHING WITH H-CLIPS (REFER TO STRUCTURAL) PRE-ENGINEERED ATTIC TRUSS @ 24" O.C. (REFER TO STRUCTURAL) R14 BATT INSULATION BETWEEN BOTTOM CORD OF TRUSSES WITH R40 BLOWN IN INSULATION ABOVE 6 MIL POLY VAPOUR BARRIER • 1 LAYER OF 5/8" GYPSUM WALLBOARD OR 1/2" GYPSUM CEILING BOARD IN WET LOCATIONS SUBSTITUTE MOISTURE RESISTANT DRYWALL FOR GYPSUM WALLBOARD. FLAT ROOF ASSEMBLY - ABOVE DECK INSULATION U-VALUE: 0.029 (R33.6) • 2 PLY SBS MODIFIED BITUMEN MEMBRANE PROTECTION BOARD PROTECTION BOARD 2" MINERAL WOOL INSULATION ON TOP OF 6" TAPERS RIGID POLYISOCYANURATE INSULATION - MIN 4" AT LOW POINT • SELF ADHERED VAPOUR RETARDER PLYWOOD SHEATHING WITH H-CLIPS (REFER TO STRUCTURAL) 2x12 JOISTS @ 24" O.C. (REFER TO STRUCTURAL) 1 LAYER OF 1/2" GYPSUM WALLBOARD · IN WET LOCATIONS SUBSTITUTE MOISTURE RESISTANT GYPSUM WALLBOARD FOR GYPSUM WALLBOARD. <u>VENTED ROOF DECK ASSEMBLY WITH PAVERS</u> U-VALUE: 0.028U (R34.75) • CONCRETE PAVERS ON ADJUSTABLE PEDESTALS • 2 PLY SBS MODIFIED BITUMEN ROOFING MEMBRANE • PLYWOOD SHEATHING WITH H-CLIPS (REFER TO STRUCTURAL) • 2x8 WOOD JOISTS @ 16" O.C. (REFER TO STRUCTURAL) WITH • 2" POLYISOCYANURATE INSULATION BAFFLES AT TOP OF JOIST SPRAY APPLIED POLYURETHANE FOAM (FILL CAVITY) • 1 LAYER OF 1/2" GYPSUM WALLBOARD EYEBROW ROOF ASSEMBLY • 2 PLY SBS MODIFIED BITUMEN MEMBRANE PLYWOOD SHEATHING WITH H-CLIPS 2x12 RAFTERS @ 16" O.C. - CUT TO PROVIDE MINIMUM 2% SLOPE. PREFINISHED PERFORATED METAL SOFFIT

ROOF ASSEMBLIES

EXTERIOR WALL ASSEMBLIES <u>ICF WALL</u> U-VALUE: 0.039U (R25.5) • LONGBOARD, FIBRE CEMENT PANEL OR CORRUGATED METAL CLADDING RAINSCREEN • SELF-ADHERED VAPOUR PERMEABLE SHEATHING MEMBRANE • 1/2" GYPSUM WALLBOARD IN WET LOCATIONS SUBSTITUTE MOISTURE RESISTANT GYPSUM WALLBOARD FOR GYPSUM WALLBOARD. · TYPE W1a: LONGBOARD SIDING • TYPE W1b: FIBRE CEMENT PANEL CLADDING • Type W1c: CORRUGATED METAL CLADDING WOOD FRAME WALL U-VALUE: 0.035U (R28.5) W2 • LONGBOARD, FIBRE CEMENT PANEL OR CORRUGATED METAL CLADDING PRESSURE TREATED WOOD STRAPPING @ 16" O.C. (PRESSURE TREAT ALL CUT SIDES) SEMI-RIGID MINERAL INSULATION (COMFORTBOARD 80) TO ALIGN WITH ICF WALL BELOW • SELF-ADHERED VAPOUR PERMEABLE SHEATHING MEMBRANE PLYWOOD SHEATHING **(REFER TO STRUCTURAL FOR SHEAR WALL LOCATIONS)** R22 BATT INSULATION • 2x6 WOOD STUDS @ 16" O.C. • 6 MIL POLY VAPOUR BARRIER • 1/2" GYPSUM WALLBOARD NOTE! • REFER TO STRUCTURAL FOR SHEAR WALL INFORMATION. • IN WET LOCATIONS SUBSTITUTE MOISTURE RESISTANT GYPSUM WALLBOARD FOR GYPSUM WALLBOARD. • TYPE W2a: LONGBOARD SIDING — TYPE W2b: FIRE CEMENT PANFI. CLADDING • TYPE W2b: FIBRE CEMENT PANEL CLADDING • Type W2c: CORRUGATED METAL CLADDING ICF WALL WITH FURRING WALL U-VALUE: 0.039U (R25.4) • CORRUGATED METAL CLADDING RAINSCREEN • SELF-ADHERED VAPOUR PERMEABLE SHEATHING MEMBRANE ICF WALL • 2x6 WOOD STUDS @ 16" O.C • 1/2" GYPSUM WALLBOARD WOOD FRAME WALL WITH FURRING WALL U-VALUE: 0.03U (R30.1) CORRUGATED METAL CLADDING PRESSURE TREATED WOOD STRAPPING @ 16" O.C. (PRESSURE TREAT ALL CUT SIDES) SEMI-RIGID MINERAL INSULATION (COMFORTBOARD 80) SELF-ADHERED VAPOUR PERMEABLE SHEATHING MEMBRANE PLYWOOD SHEATHING **(REFER TO STRUCTURAL FOR SHEAR WALL LOCATIONS)** R22 BATT INSULATION • 2x6 WOOD STUDS @ 16" O.C. • 6 MIL POLY VAPOUR BARRIER FURRING TO ALIGN WITH ICF • 1/2" GYPSUM WALLBOARD PARAPET ASSEMBLY - VENTED • 22 ga PREFINISHED METAL FLASHING - CAP FLASHING WITH DRIP EDGE HARDIF PANEL FASCIA • SELF ADHERED VAPOUR PERMEABLE WATERPROOF SHEATHING MEMBRANE • PLYWOOD SHEATHING **(REFER TO STRUCTURAL FOR SHEAR WALL LOCATIONS)** • 2x4 WOOD STUDS @ 16" O.C. • 1/2" PLYWOOD SHEATHING • 2 PLY SBS MODIFIED BITUMEN ROOFING MEMBRANE

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P1 PARTITION 1 - TYPICAL ICF PARTITION WALL
1.0 HR. F.R.R.
         • 5/8" TYPE 'X' GYPSUM WALLBOARD
         • 5/8" TYPE 'X' GYPSUM WALLBOARD
 P2 PARTITION 2 - 2x4 WOOD PARTITION
         • 1/2" GYPSUM WALLBOARD
         • 2x4 WOOD STUDS @ 16" O.C.
         • ACOUSTIC INSULATION @ BEDROOM AND WASHROOM SEPARATIONS
         • 1/2" GYPSUM WALLBOARD
         IN WET LOCATIONS SUBSTITUTE MOISTURE RESISTANT GYPSUM WALLBOARD FOR GYPSUM WALLBOARD.
       PARTITION 3 - 2x6 WOOD PARTITION
         • 1/2" GYPSUM WALLBOARD
         • 2x6 WOOD STUDS @ 16" O.C
         • ACOUSTIC INSULATION @ BEDROOM AND WASHROOM SEPARATIONS
         • 1/2" GYPSUM WALLBOARD
         IN WET LOCATIONS SUBSTITUTE MOISTURE RESISTANT GYPSUM WALLBOARD FOR GYPSUM WALLBOARD.
       PARTITION 4 - ICF PARTITION W/ FURRING ONE SIDE
         • 1/2" GYPSUM WALLBOARD
         • 2x6 WOOD STUDS @ 16" O.C.

    ICF WALL

         • 1/2" GYPSUM WALLBOARD
         · IN WET LOCATIONS SUBSTITUTE MOISTURE RESISTANT GYPSUM WALLBOARD FOR GYPSUM WALLBOARD.
       PARTITION 5 - ICF PARTITION W/ FURRING BOTH SIDE
         • 1/2" GYPSUM WALLBOARD
         • 2x6 WOOD STUDS @ 16" O.C.
         • 2x6 WOOD STUDS @ 16" O.C.
         • 1/2" GYPSUM WALLBOARD
         IN WET LOCATIONS SUBSTITUTE MOISTURE RESISTANT GYPSUM WALLBOARD FOR GYPSUM WALLBOARD.
       PARTITION 6 - ICF PARTITION W/ 2x4 FURRING ONE SIDE
         • 1/2" GYPSUM WALLBOARD

    2x4 WOOD STUDS @ 16" O.C.

    ICF WALL

         • 1/2" GYPSUM WALLBOARD
         IN WET LOCATIONS SUBSTITUTE MOISTURE RESISTANT GYPSUM WALLBOARD FOR GYPSUM WALLBOARD.
        PARTITION 7 - RATED WOOD PARTITION
         • 5/8" TYPE 'X' GYPSUM WALLBOARD
         • 2x4 WOOD STUDS @ 16" O.C.
         • 6MIL POLY VAPOUR BARRIER TO INTERIOR SIDE OF GARAGE WALL
         • 5/8" TYPE 'X' GYPSUM WALLBOARD
 P8 PARTITION 3 - 2x4 ELEVATOR PARTITION
         • 1/2" GYPSUM WALLBOARD
         • 5/8" PLYWOOD SHEATHING (REFER TO STRUCTURAL)
         • 2x4 WOOD STUDS @ 16" O.C.

    WOOD BLOCKING AS PER ELEVATOR MANUFACTURES REQUIREMENTS

          • 1/2" GYPSUM WALLBOARD
FOUNDATION WALL ASSEMBLIES
      ICF FOUNDATION WALL 1
0.04U (R24.2)
         • FILTER FABRIC

    DRAIN ROCK

    POLYETHYLENE DRAINAGE MAT

    SELF ADHERED SBS WATERPROOF MEMBRANE

         • ICF FOUNDATION WALL (REFER TO STRUCTURAL)
         • IN WET LOCATIONS SUBSTITUTE MOISTURE RESISTANT GYPSUM WALLBOARD FOR GYPSUM WALLBOARD.
 FD2 FOUNDATION WALL 2
         • ICF FOUNDATION WALL (REFER TO STRUCTURAL)
 FD3 RETAINING WALL FOUNDATION
         • CLEAN BACKFILL
• FILTER FABRIC

    DRAIN ROCK

    POLYETHYLENE DRAINAGE MAT

         • SELF ADHERED SBS WATERPROOF MEMBRANE
• 6" FOUNDATION WALL (REFER TO STRUCTURAL)
 FD4 FOUNDATION WALL 3
         • 6" FOUNDATION WALL (REFER TO STRUCTURAL)
FLOOR ASSEMBLIES
F1 CONCRETE SLAB - GARAGE
         • FLOOR FINISH BY OWNER
• 4" REINFORCED CONCRETE SLAB
         • 10 mil POLY VAPOUR BARRIER

    COMPACTED INORGANIC FILL

    BEARING SOIL

        SLAB ON GRADE - HOUSE
U-VALUE: 0.06U (R16.1)
         • FLOOR FINISH BY OWNER
        • 4" REINFORCED CONCRETE SLAB ON GRADE
• 10 mil POLYETHYLENE VAPOUR BARRIER.
         • R15 (3") RIGID INSULATION

    COMPÁCTED INORGANIC GRAVEL FILL

    BEARING SOIL

         • EXTEND RIGID INSULATION 48" IN FROM FOUNDATION WALL.
       FLOOR ASSEMBLY

    FLOOR FINISH BY OWNER

         • TONGUE & GROOVE PLYWOOD SHEATHING (REFER TO STRUCTURAL)
         • ENGINEERED TJI'S (REFER TO STRUCTURAL SIZING AND SPACING)
• ACOUSTIC BATT INSULATION TO FILL CAVITY

    RESILIENT CHANNELS

         • 2 LAYERS 5/8" TYPE 'X' GYPSUM WALLBOARD
         · IN WET LOCATIONS SUBSTITUTE MOISTURE RESISTANT GYPSUM CEILING BOARD FOR GYPSUM WALLBOARD
          • ***ADD 6MIL POLY VAPOUR BARRIER TO INTERIOR SIDE OF GARAGE CEILING***
       STAIR LANDING
         • FLOOR FINISH BY OWNER
        • 5/8" TONGUE & GROOVE PLYWOOD SHEATHING (REFER TO STRUCTURAL)
• 2x10 WOOD JOISTS @ 16" O.C. (REFER TO STRUCTURAL)
• 1/2" GYPSUM CEILING BOARD
       DECK ASSEMBLY WITH PAVERS

    NO FUZZY BACK VINYL DECKING

         • 5/8" TONGUE & GROOVE PLYWOOD SHEATHING (REFER TO STRUCTURAL)


    WOOD TAPERS


        • 2x10 WOOD JOISTS @ 16" O.C. (REFER TO STRUCTURAL)
• PERFORATED PREFINISHED METAL SOFFIT
       FLOOR ASSEMBLY
         • FLOOR FINISH BY OWNER

    FLOOR FINISH BY OWNER
    TONGUE & GROOVE PLYWOOD SHEATHING (REFER TO STRUCTURAL)
    ENGINEERED TJI's (REFER TO STRUCTURAL SIZING AND SPACING)
    ACCUSTIC BATT INSULATION TO FILL CAVITY

         • 1/2" GYPSUM WALLBOARD
         · IN WET LOCATIONS SUBSTITUTE MOISTURE RESISTANT GYPSUM CEILING BOARD FOR GYPSUM WALLBOARD
       CONCRETE SLAB - EXTERIOR PATIO
         • 4" REINFORCED CONCRETE SLAB - SMOOTH FINISH
        • COMPACTED INORGANIC FILL
• BEARING SOIL
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INTERIOR WALL ASSEMBLIES



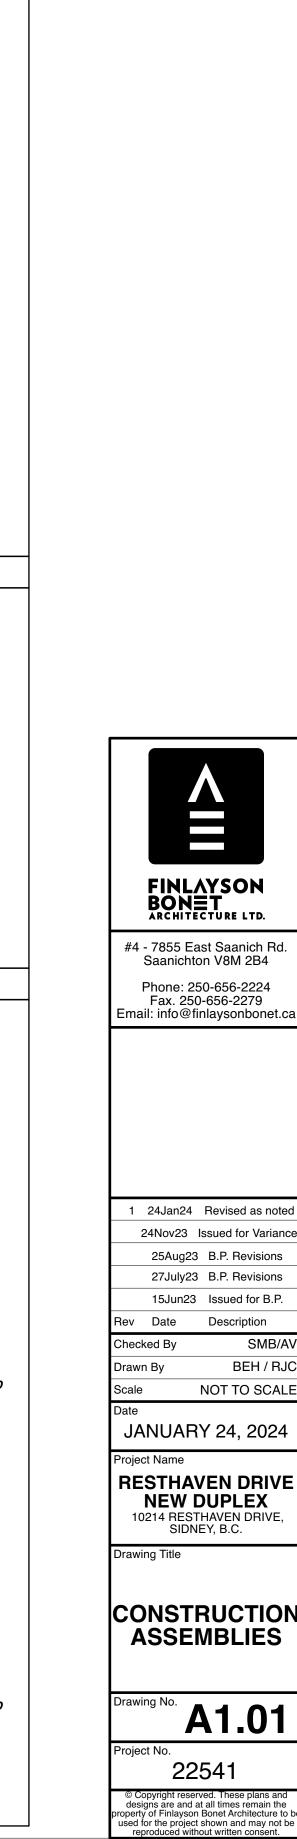

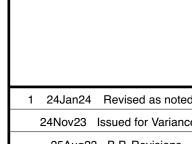25Aug23 B.P. Revisions 27July23 B.P. Revisions 15Jun23 Issued for B.P. Rev Date Description Checked By SMB/AV BEH / RJ0 Drawn By


NOT TO SCALE JANUARY 24, 2024

RESTHAVEN DRIVE NEW DUPLEX 10214 RESTHAVEN DRIVE, SIDNEY, B.C.


CONSTRUCTION **ASSEMBLIES**

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SYMBOL LEGEND ■ 0 KEY NOTE TAG → A MATERIALS TAG CONCRETE RETAINING WALL ₩ ICF WALL STUD FRAME WALL SHEAR WALL SECTION MARKER —· CARBON MONOXIDE DETECTOR



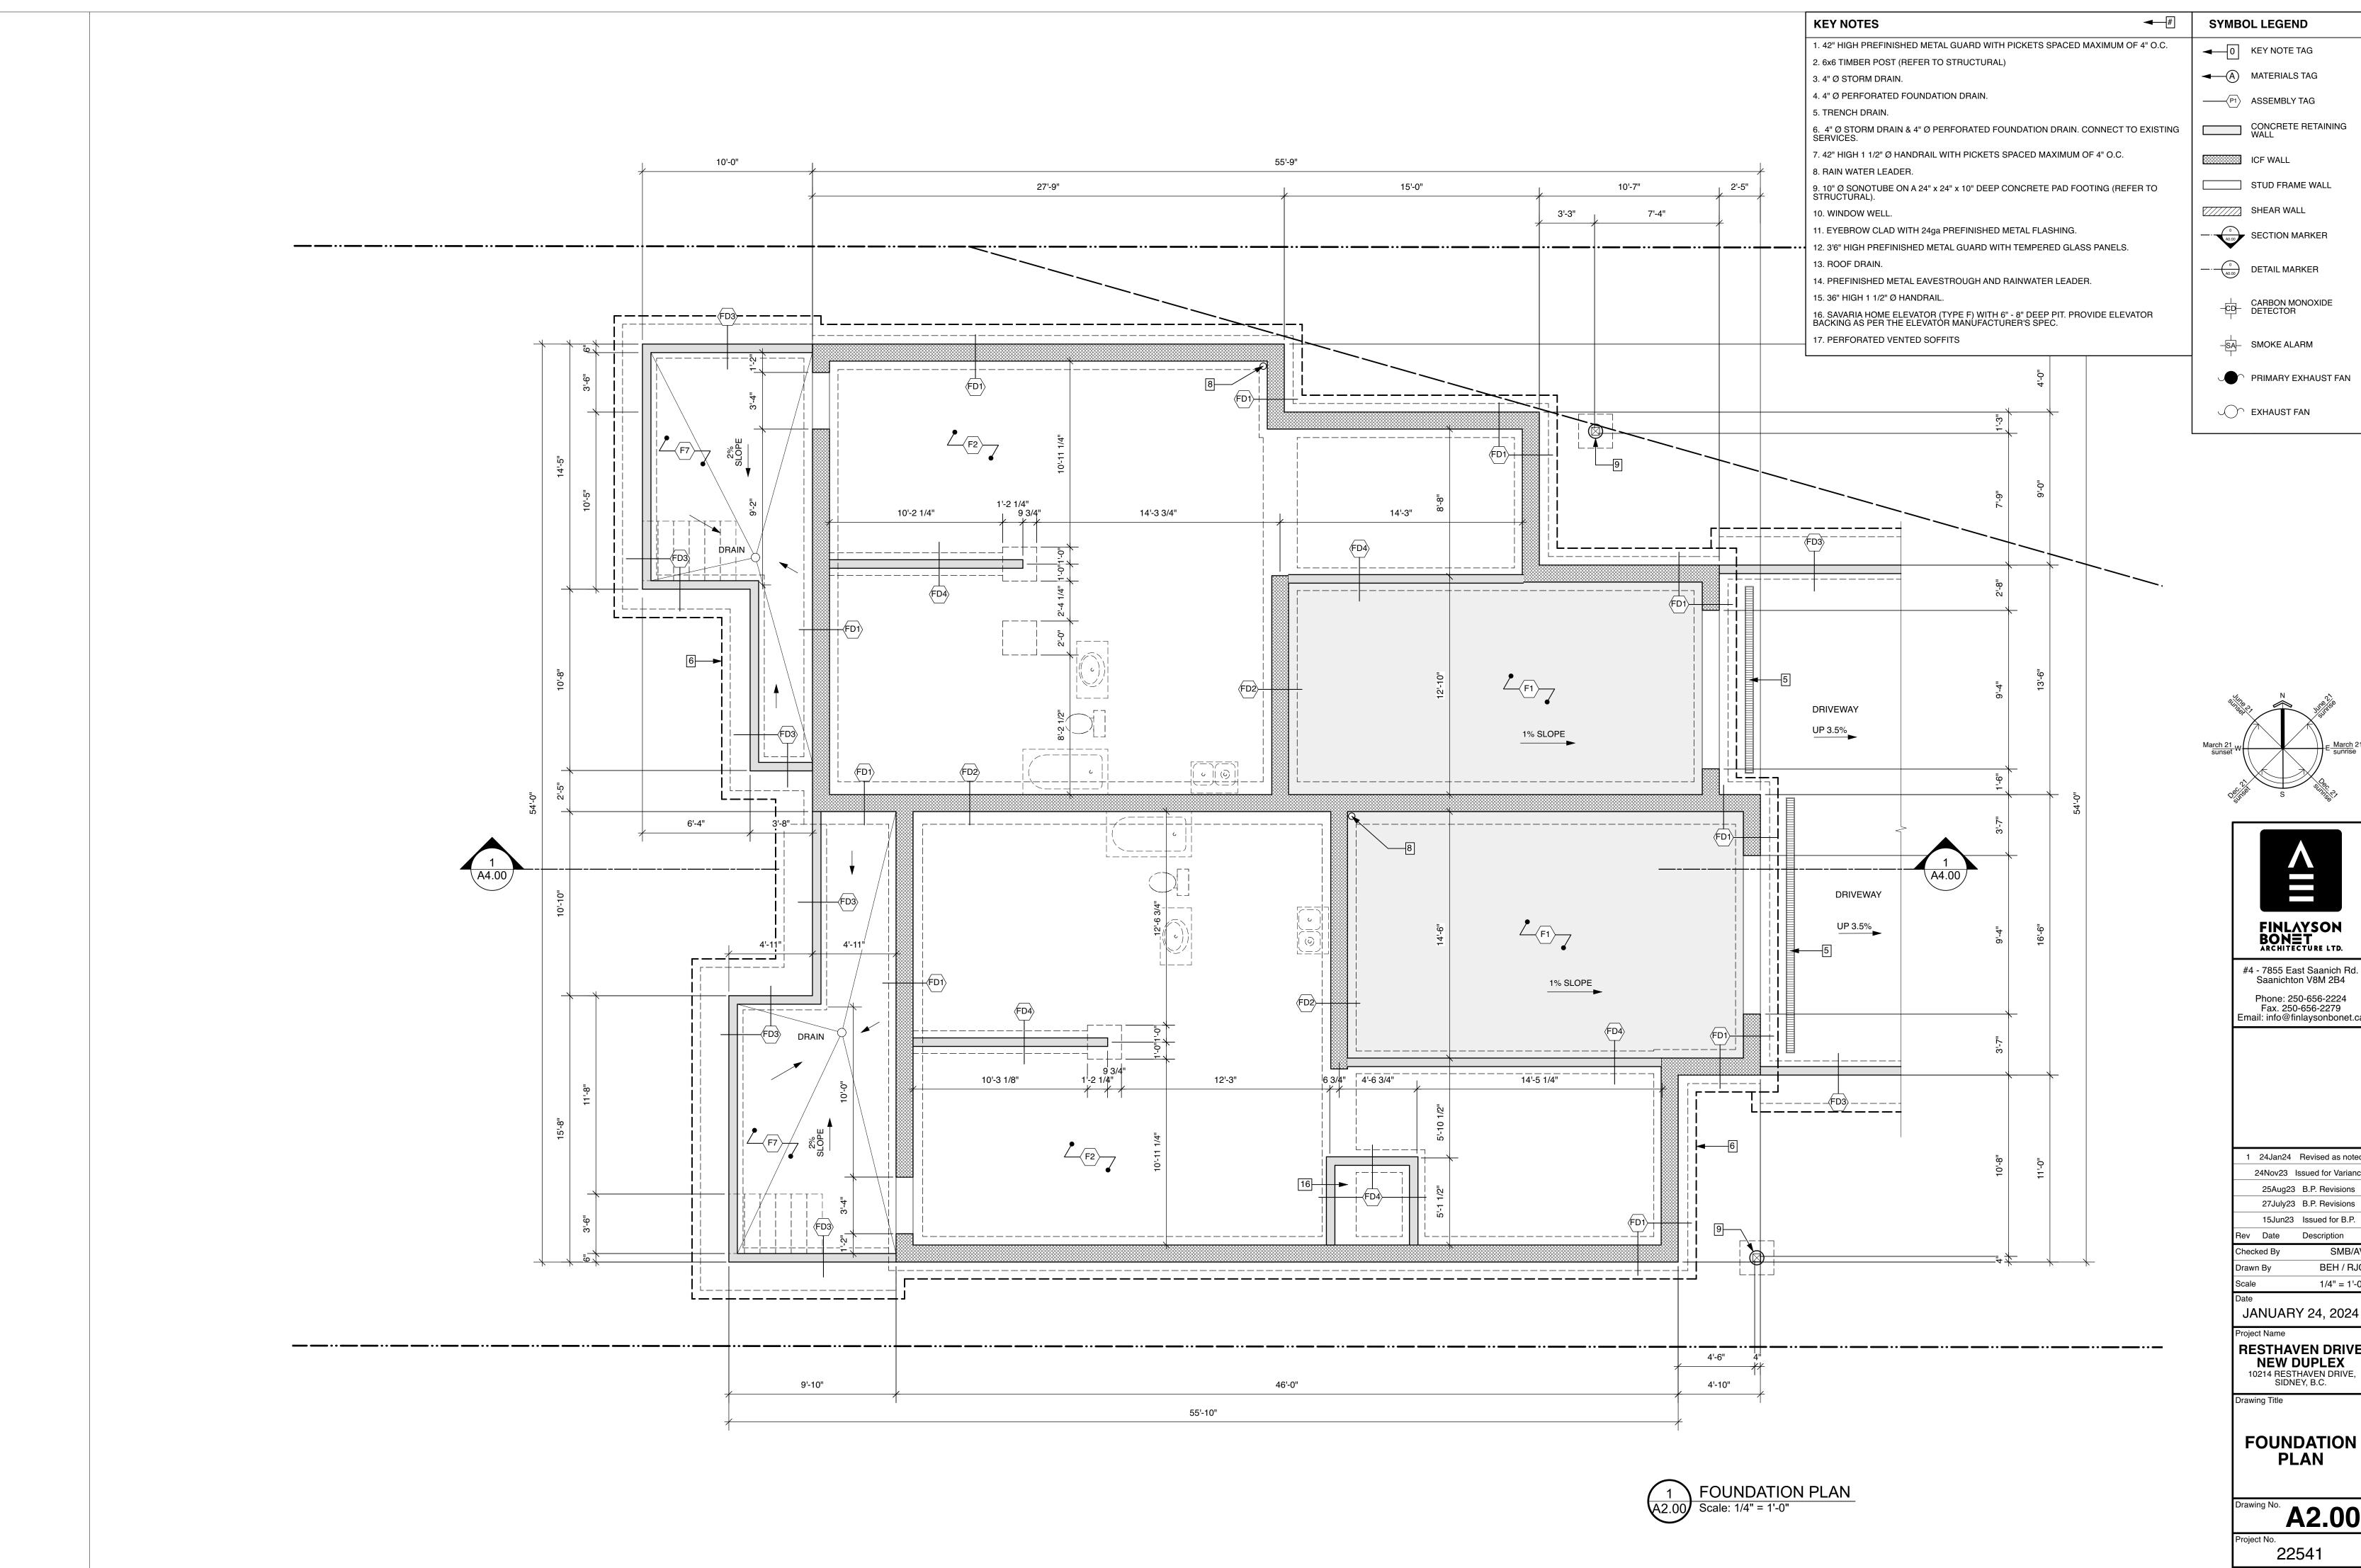

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Description SMB/AV BEH / RJC 1/4" = 1'-0"

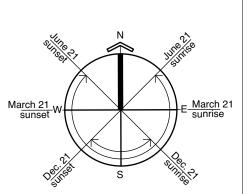
JANUARY 24, 2024


RESTHAVEN DRIVE


NEW DUPLEX 10214 RESTHAVEN DRIVE, SIDNEY, B.C.

A2.00

22541

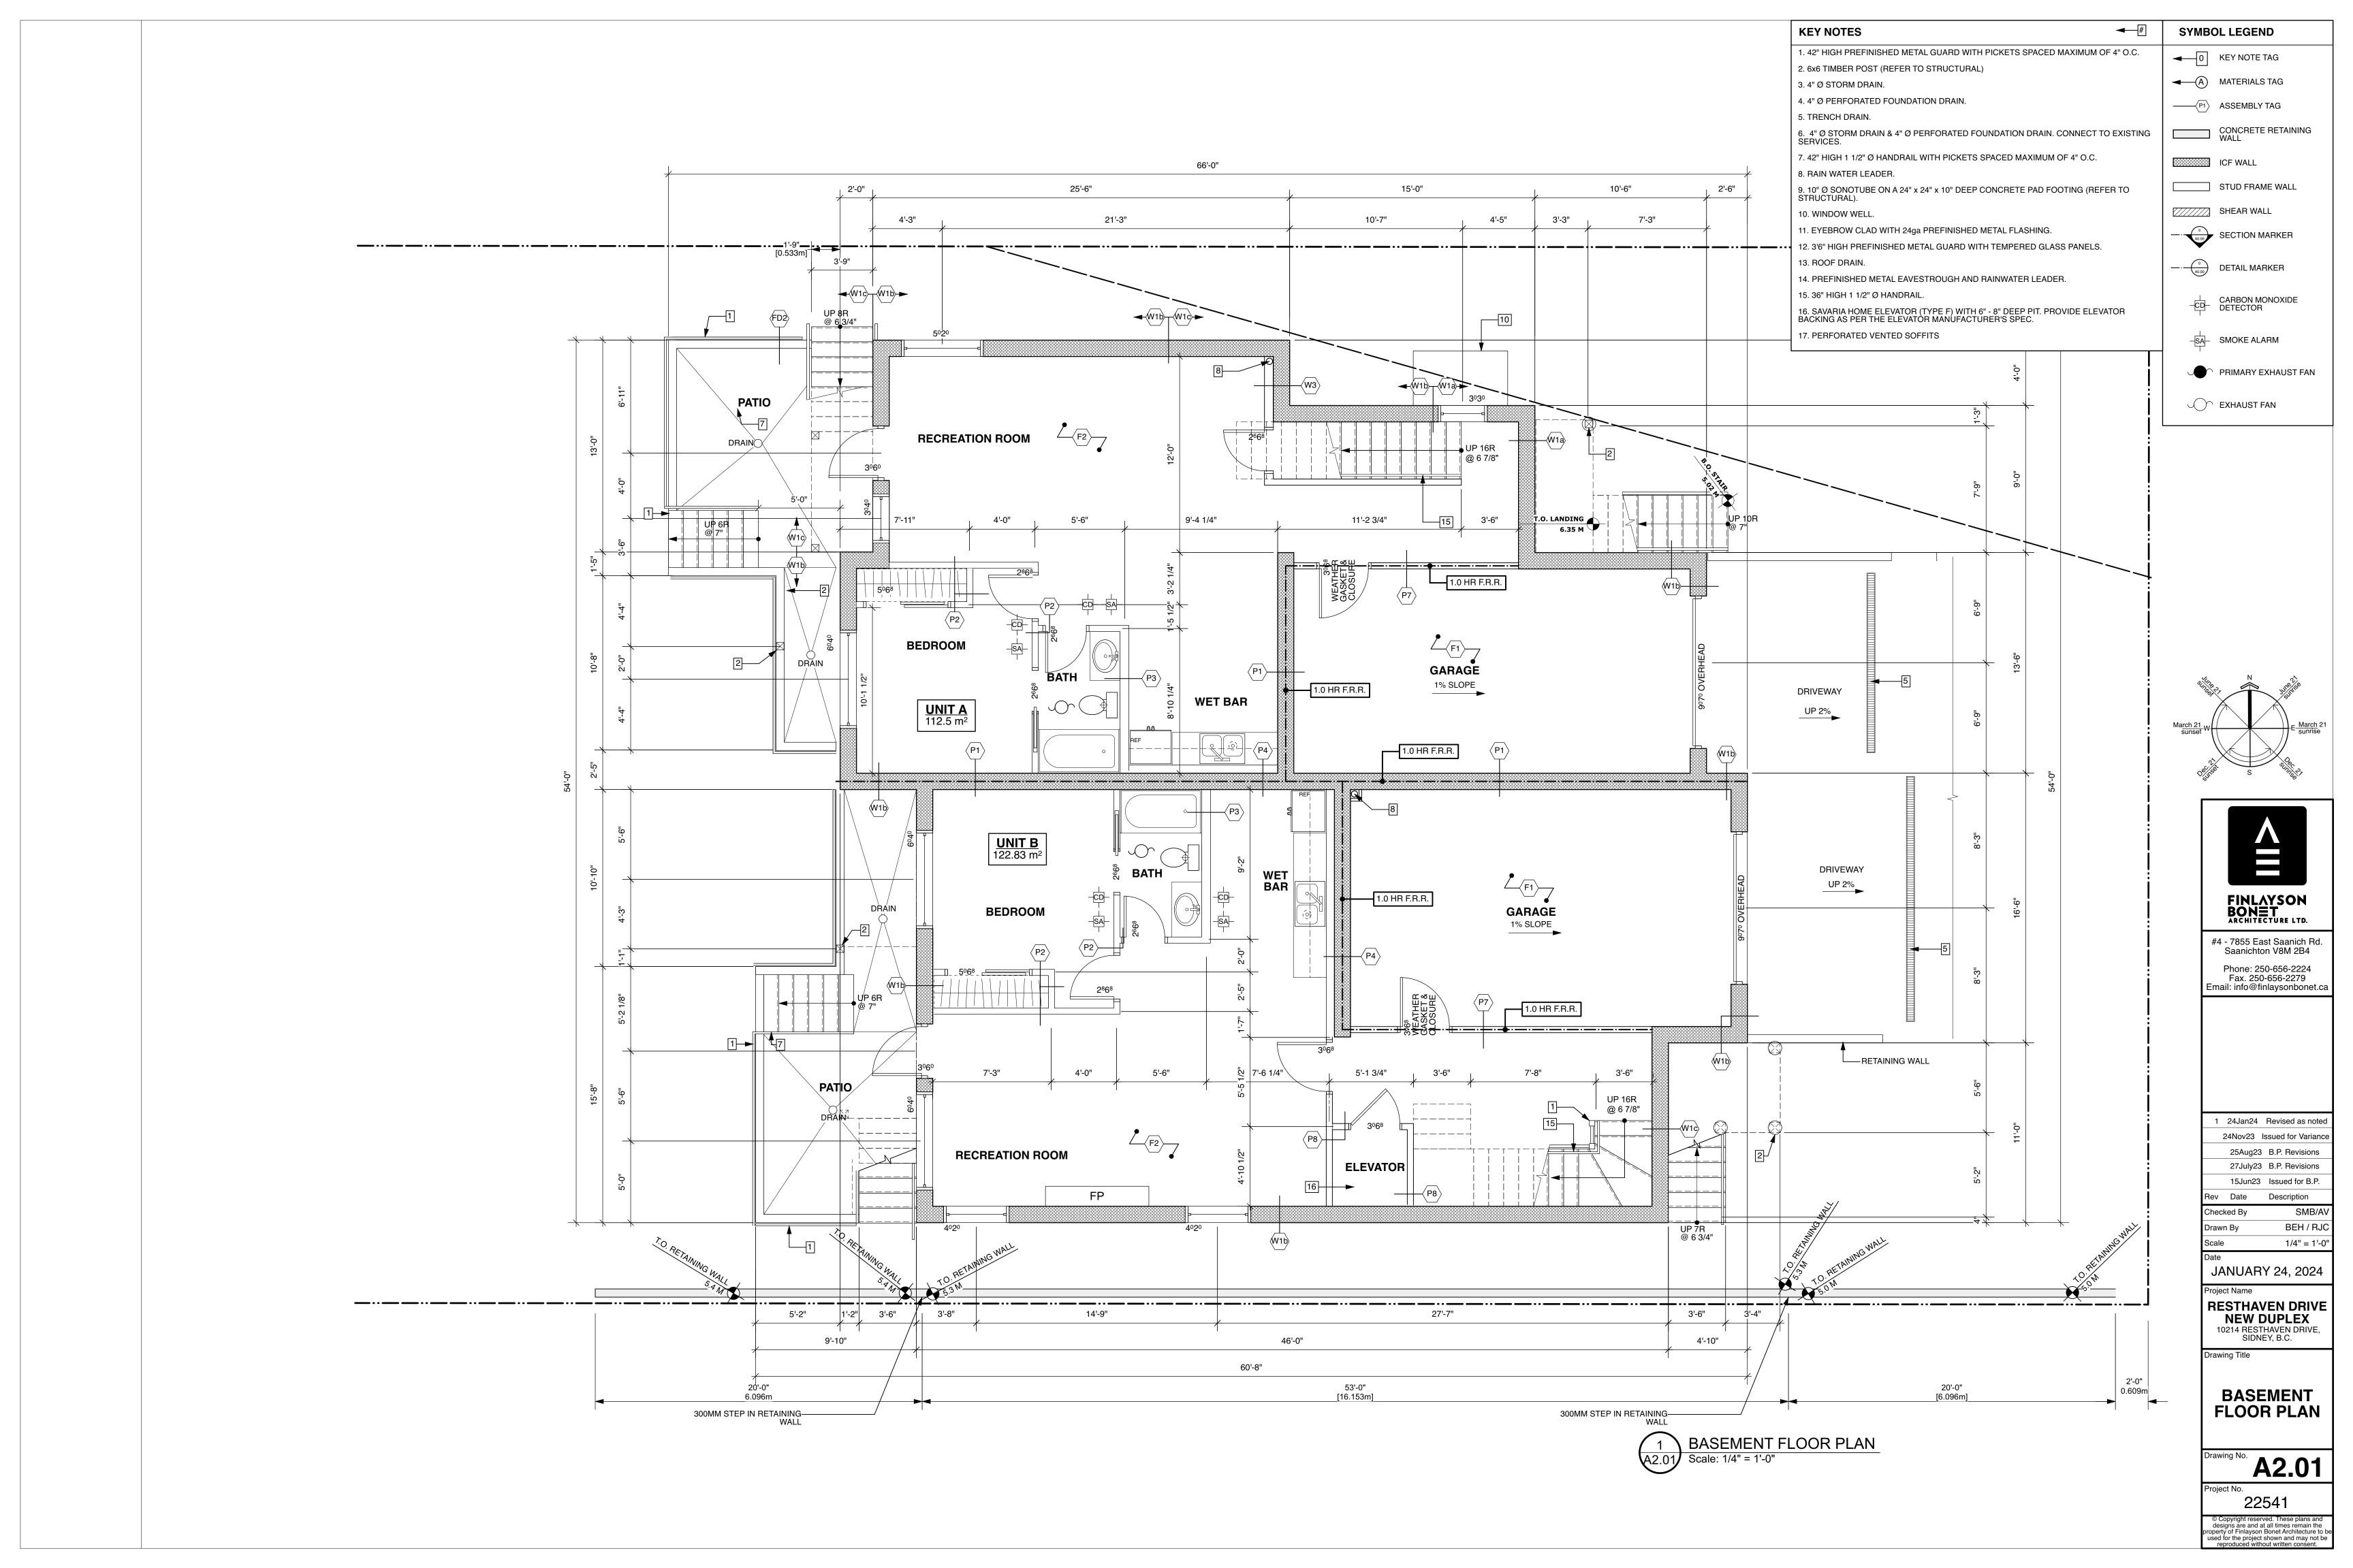

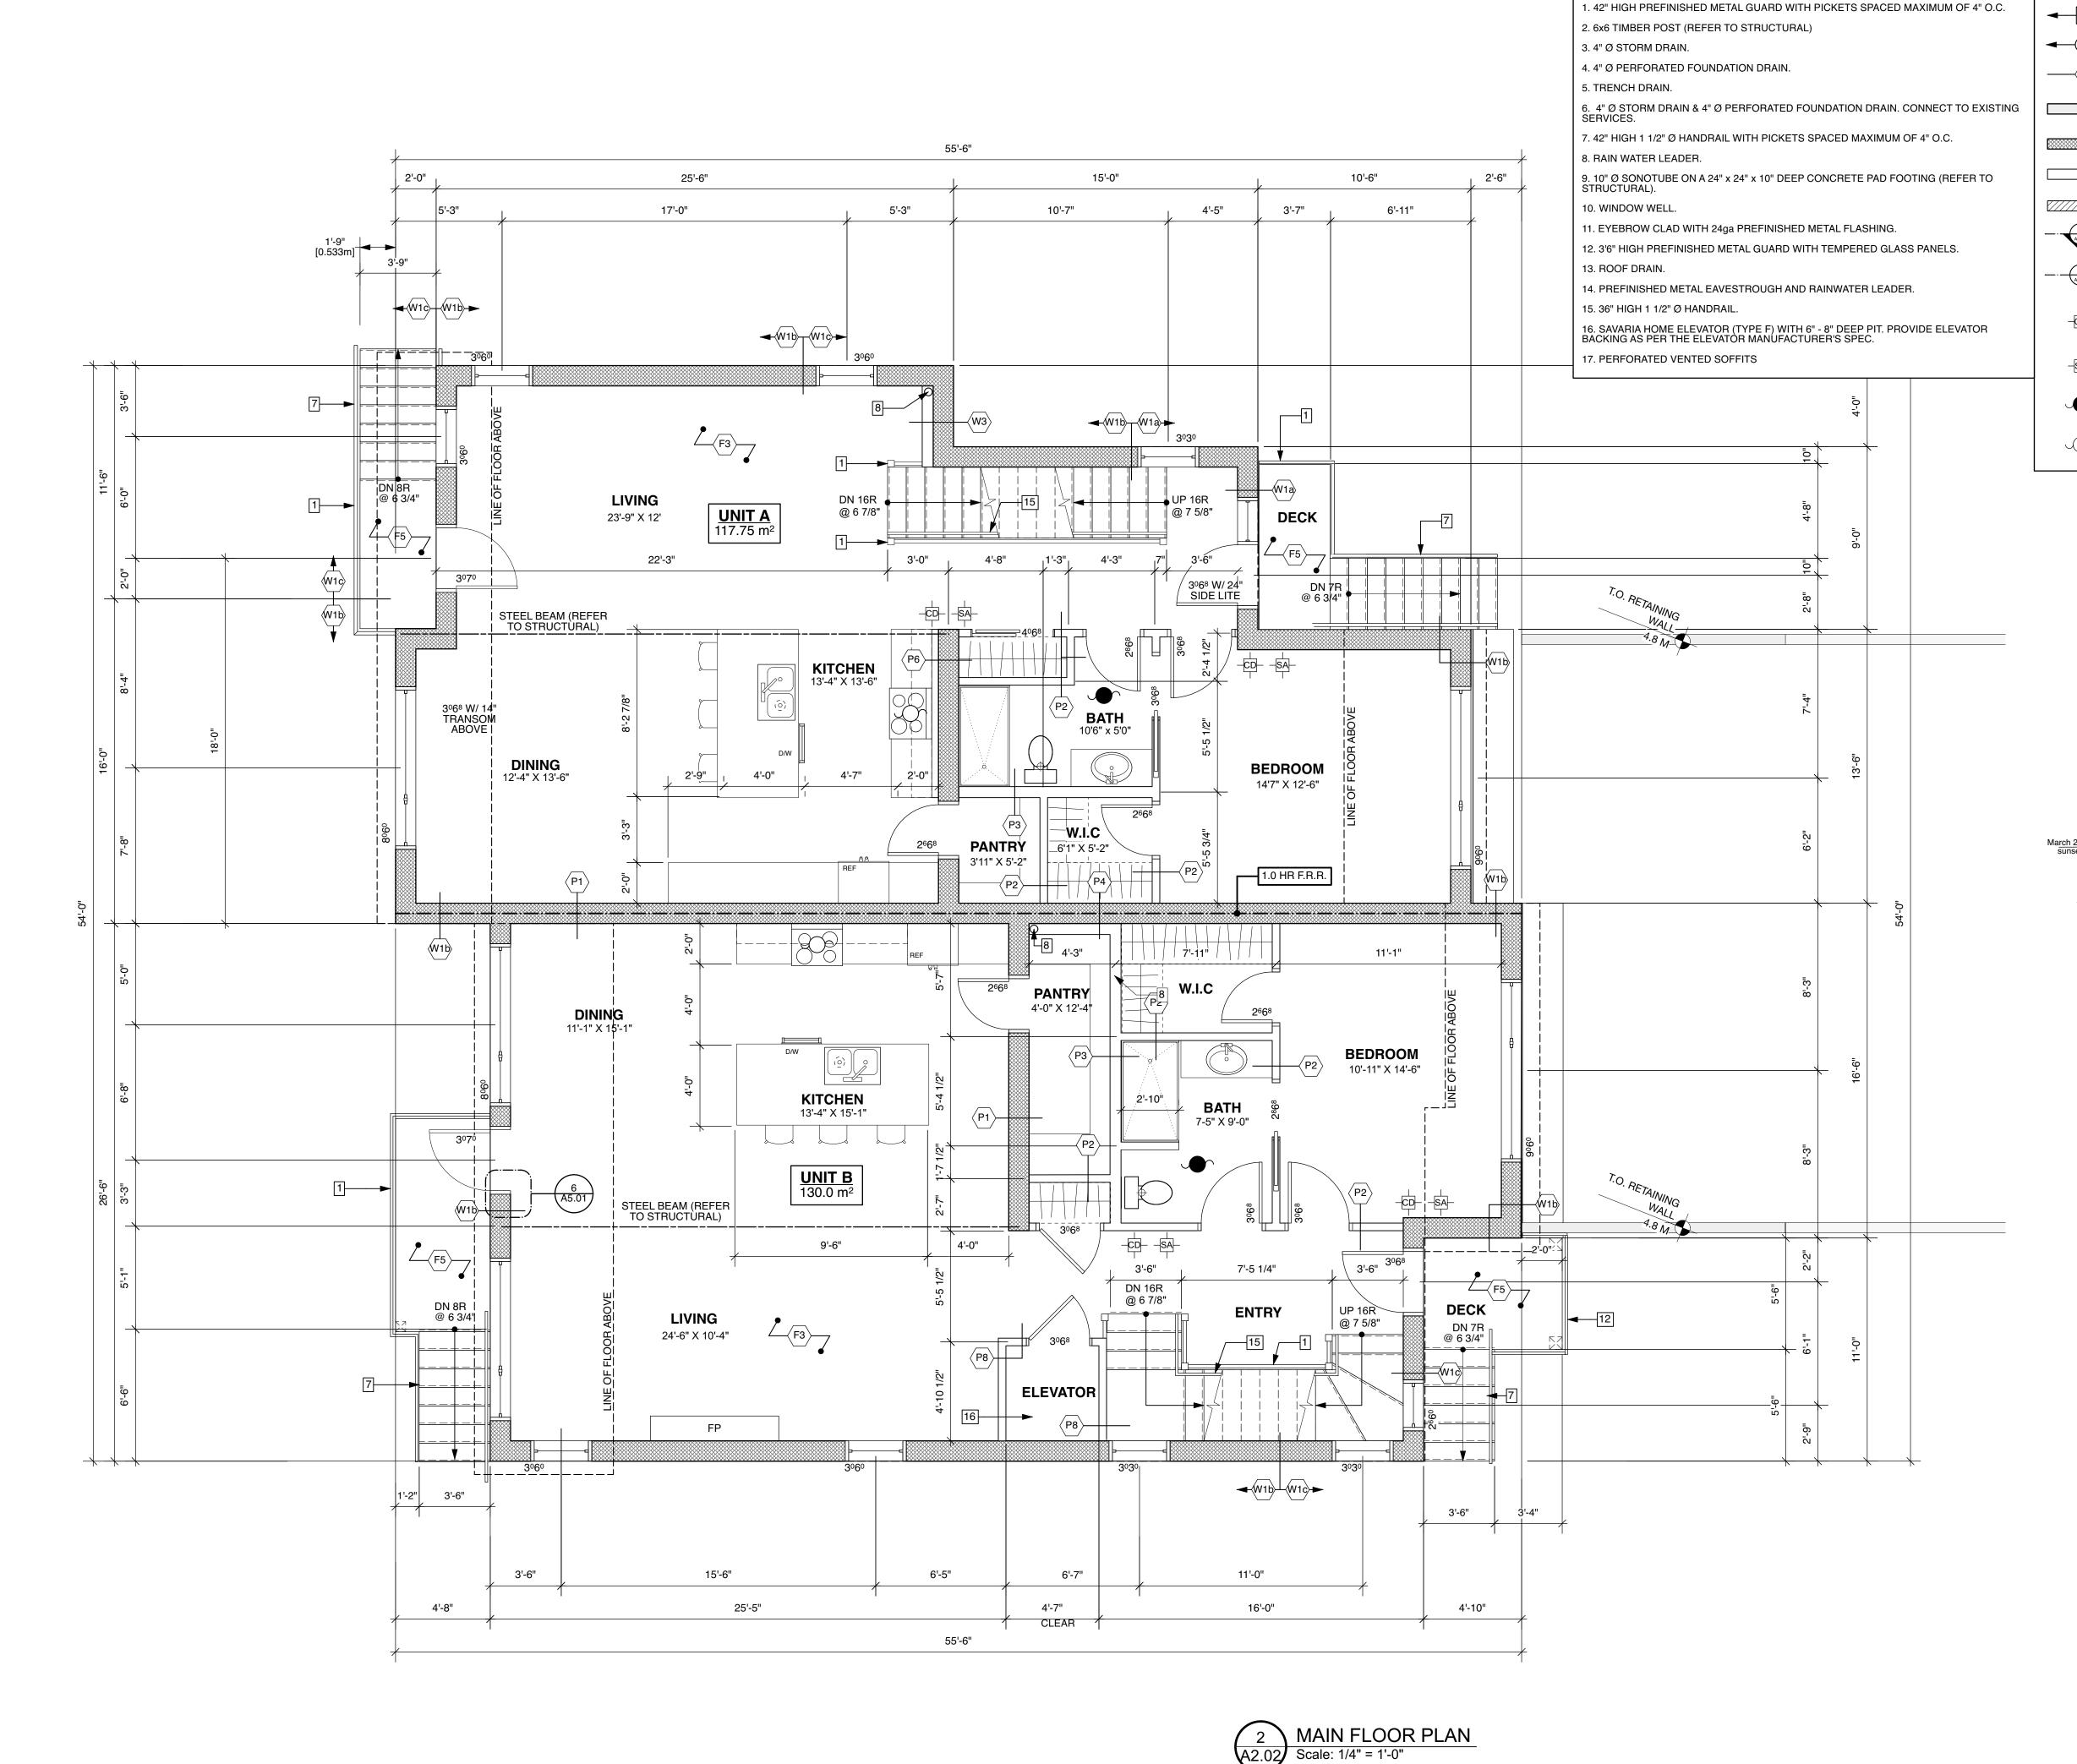

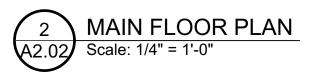

SYMBOL LEGEND

KEY NOTES

■ 0 KEY NOTE TAG

■ MATERIALS TAG

CONCRETE RETAINING WALL

₩ ICF WALL STUD FRAME WALL

SHEAR WALL

SECTION MARKER

—·

CARBON MONOXIDE DETECTOR -SA- SMOKE ALARM

PRIMARY EXHAUST FAN

EXHAUST FAN



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JANUARY 24, 2024


RESTHAVEN DRIVE NEW DUPLEX 10214 RESTHAVEN DRIVE, SIDNEY, B.C.


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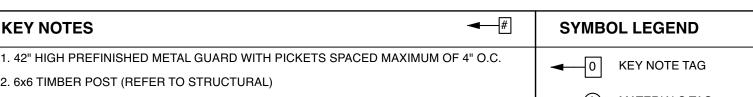
MAIN FLOOR PLAN

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KEY NOTES

◆ MATERIALS TAG

CONCRETE RETAINING WALL

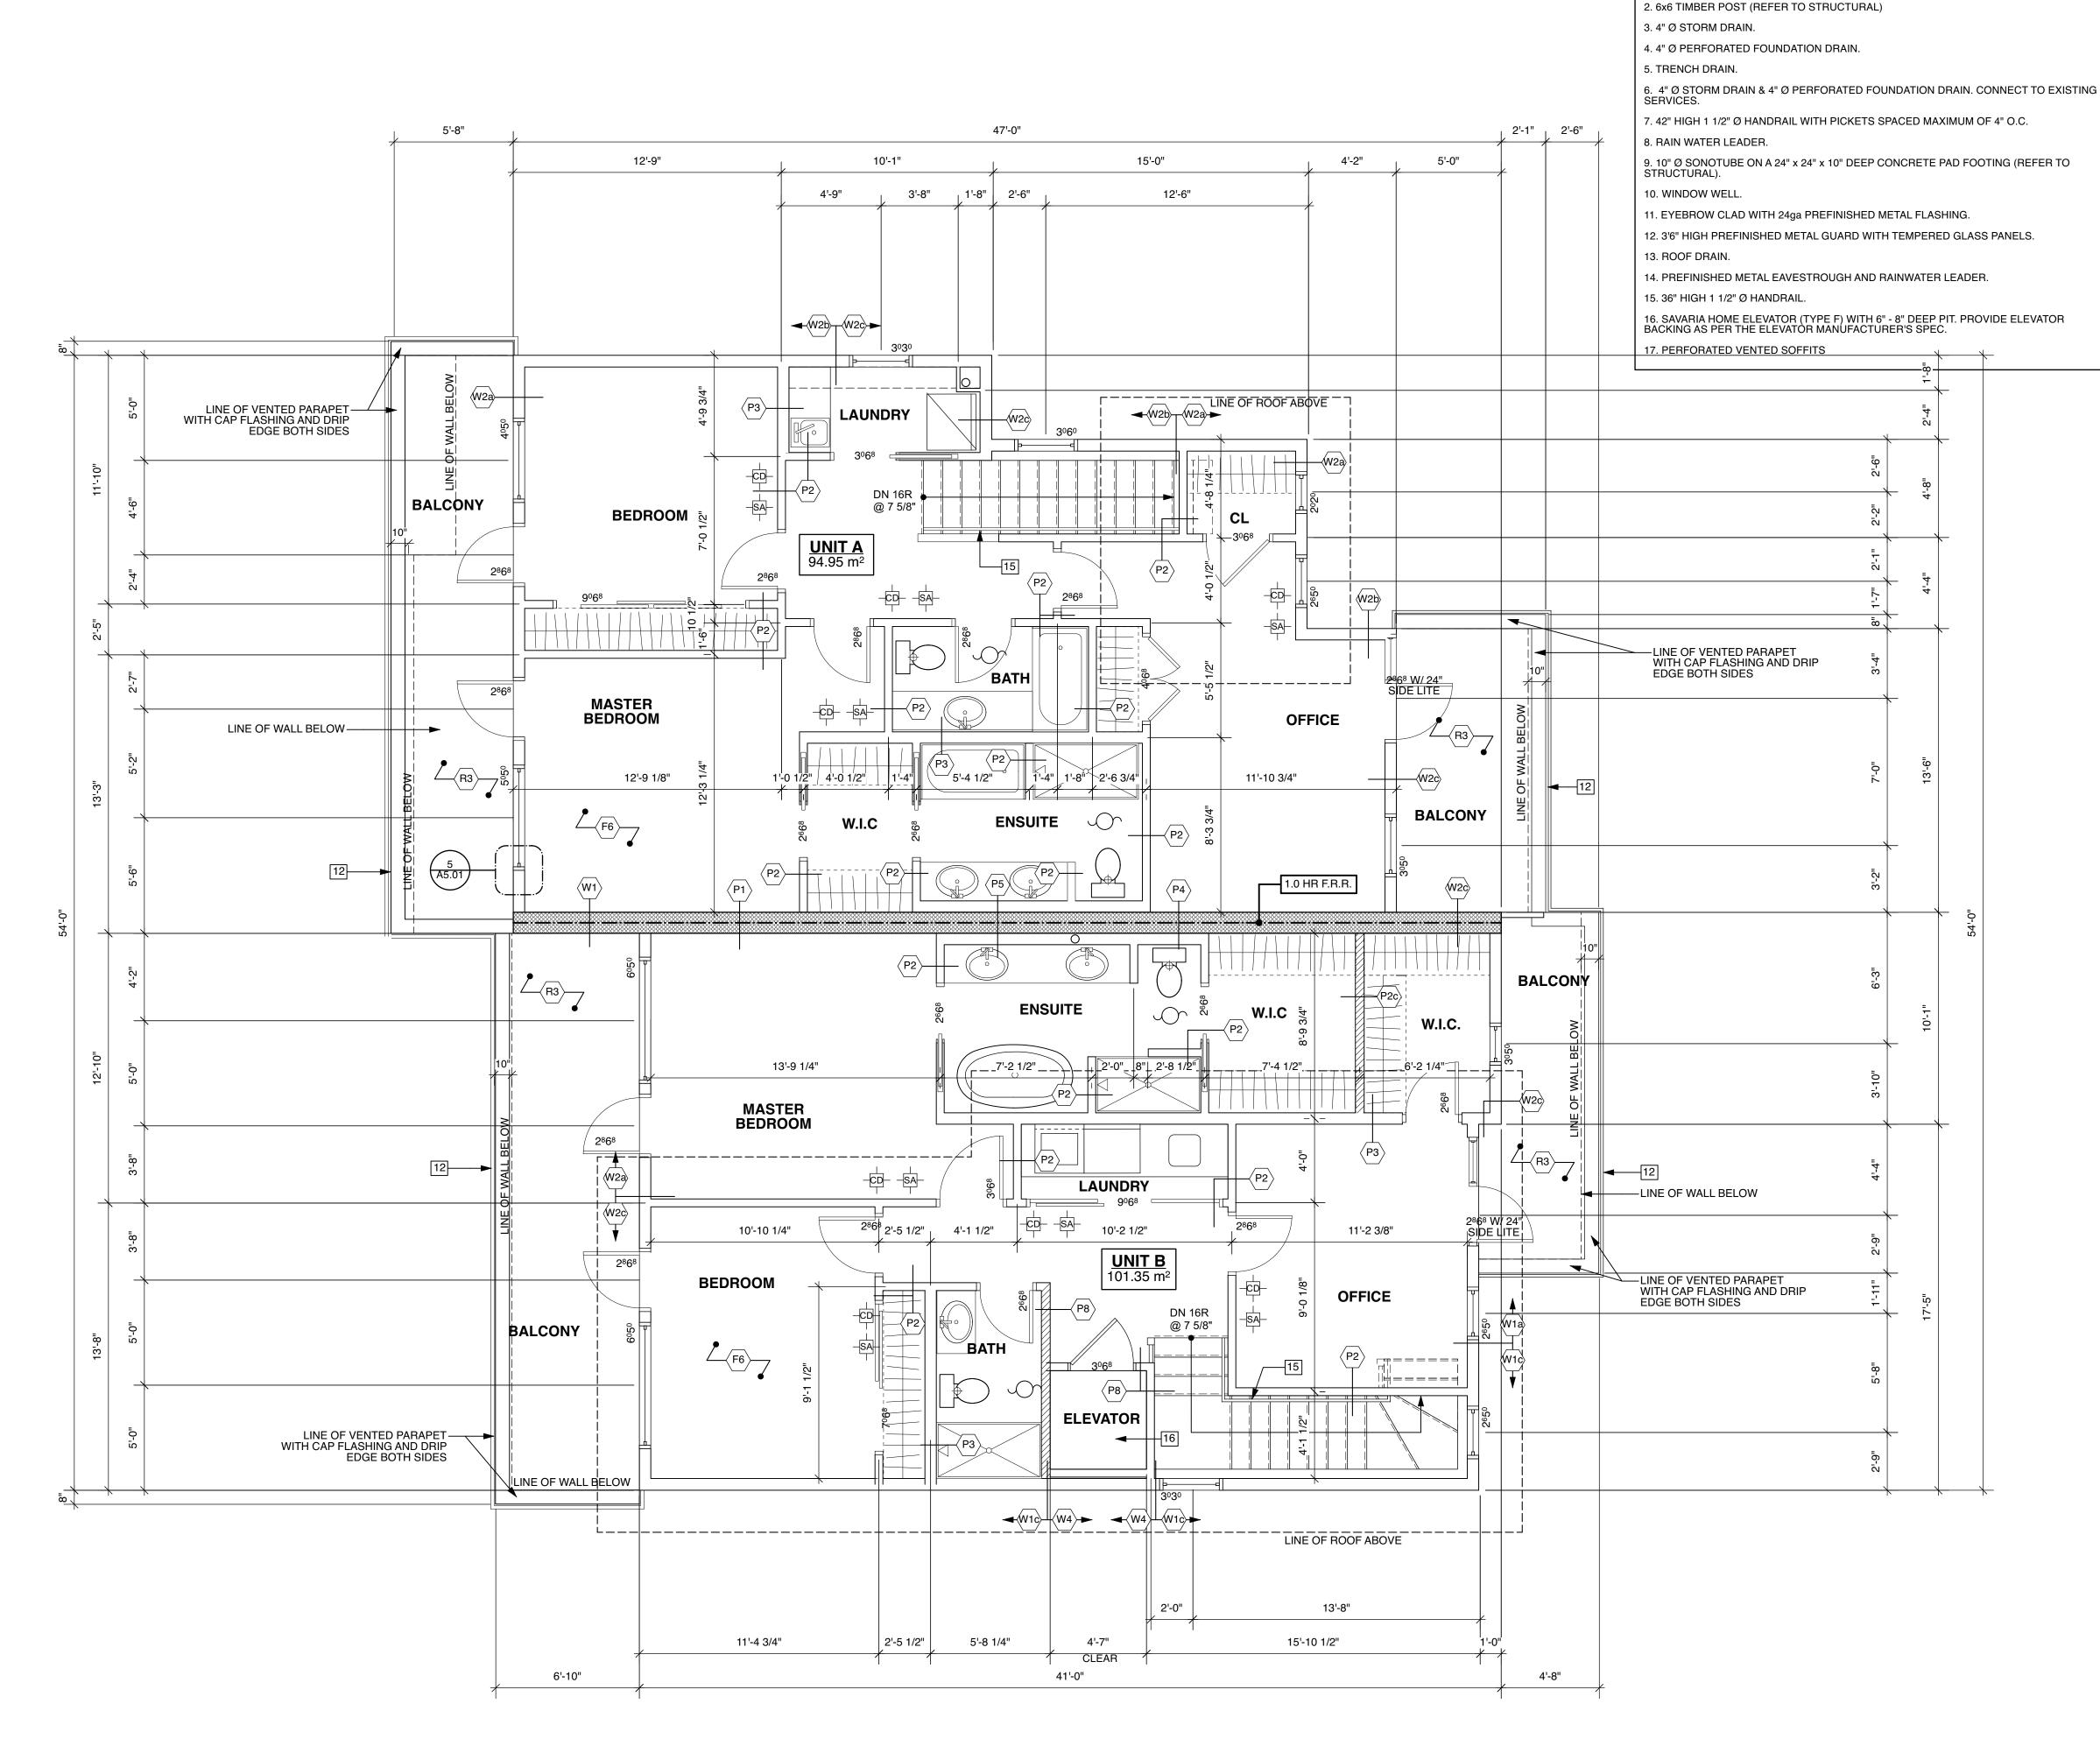₩ ICF WALL

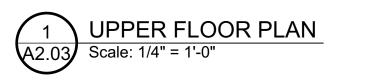STUD FRAME WALL SHEAR WALL


SECTION MARKER

—· ODETAIL MARKER CARBON MONOXIDE DETECTOR

-SA- SMOKE ALARM

PRIMARY EXHAUST FAN

EXHAUST FAN

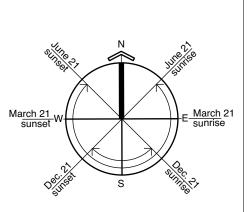



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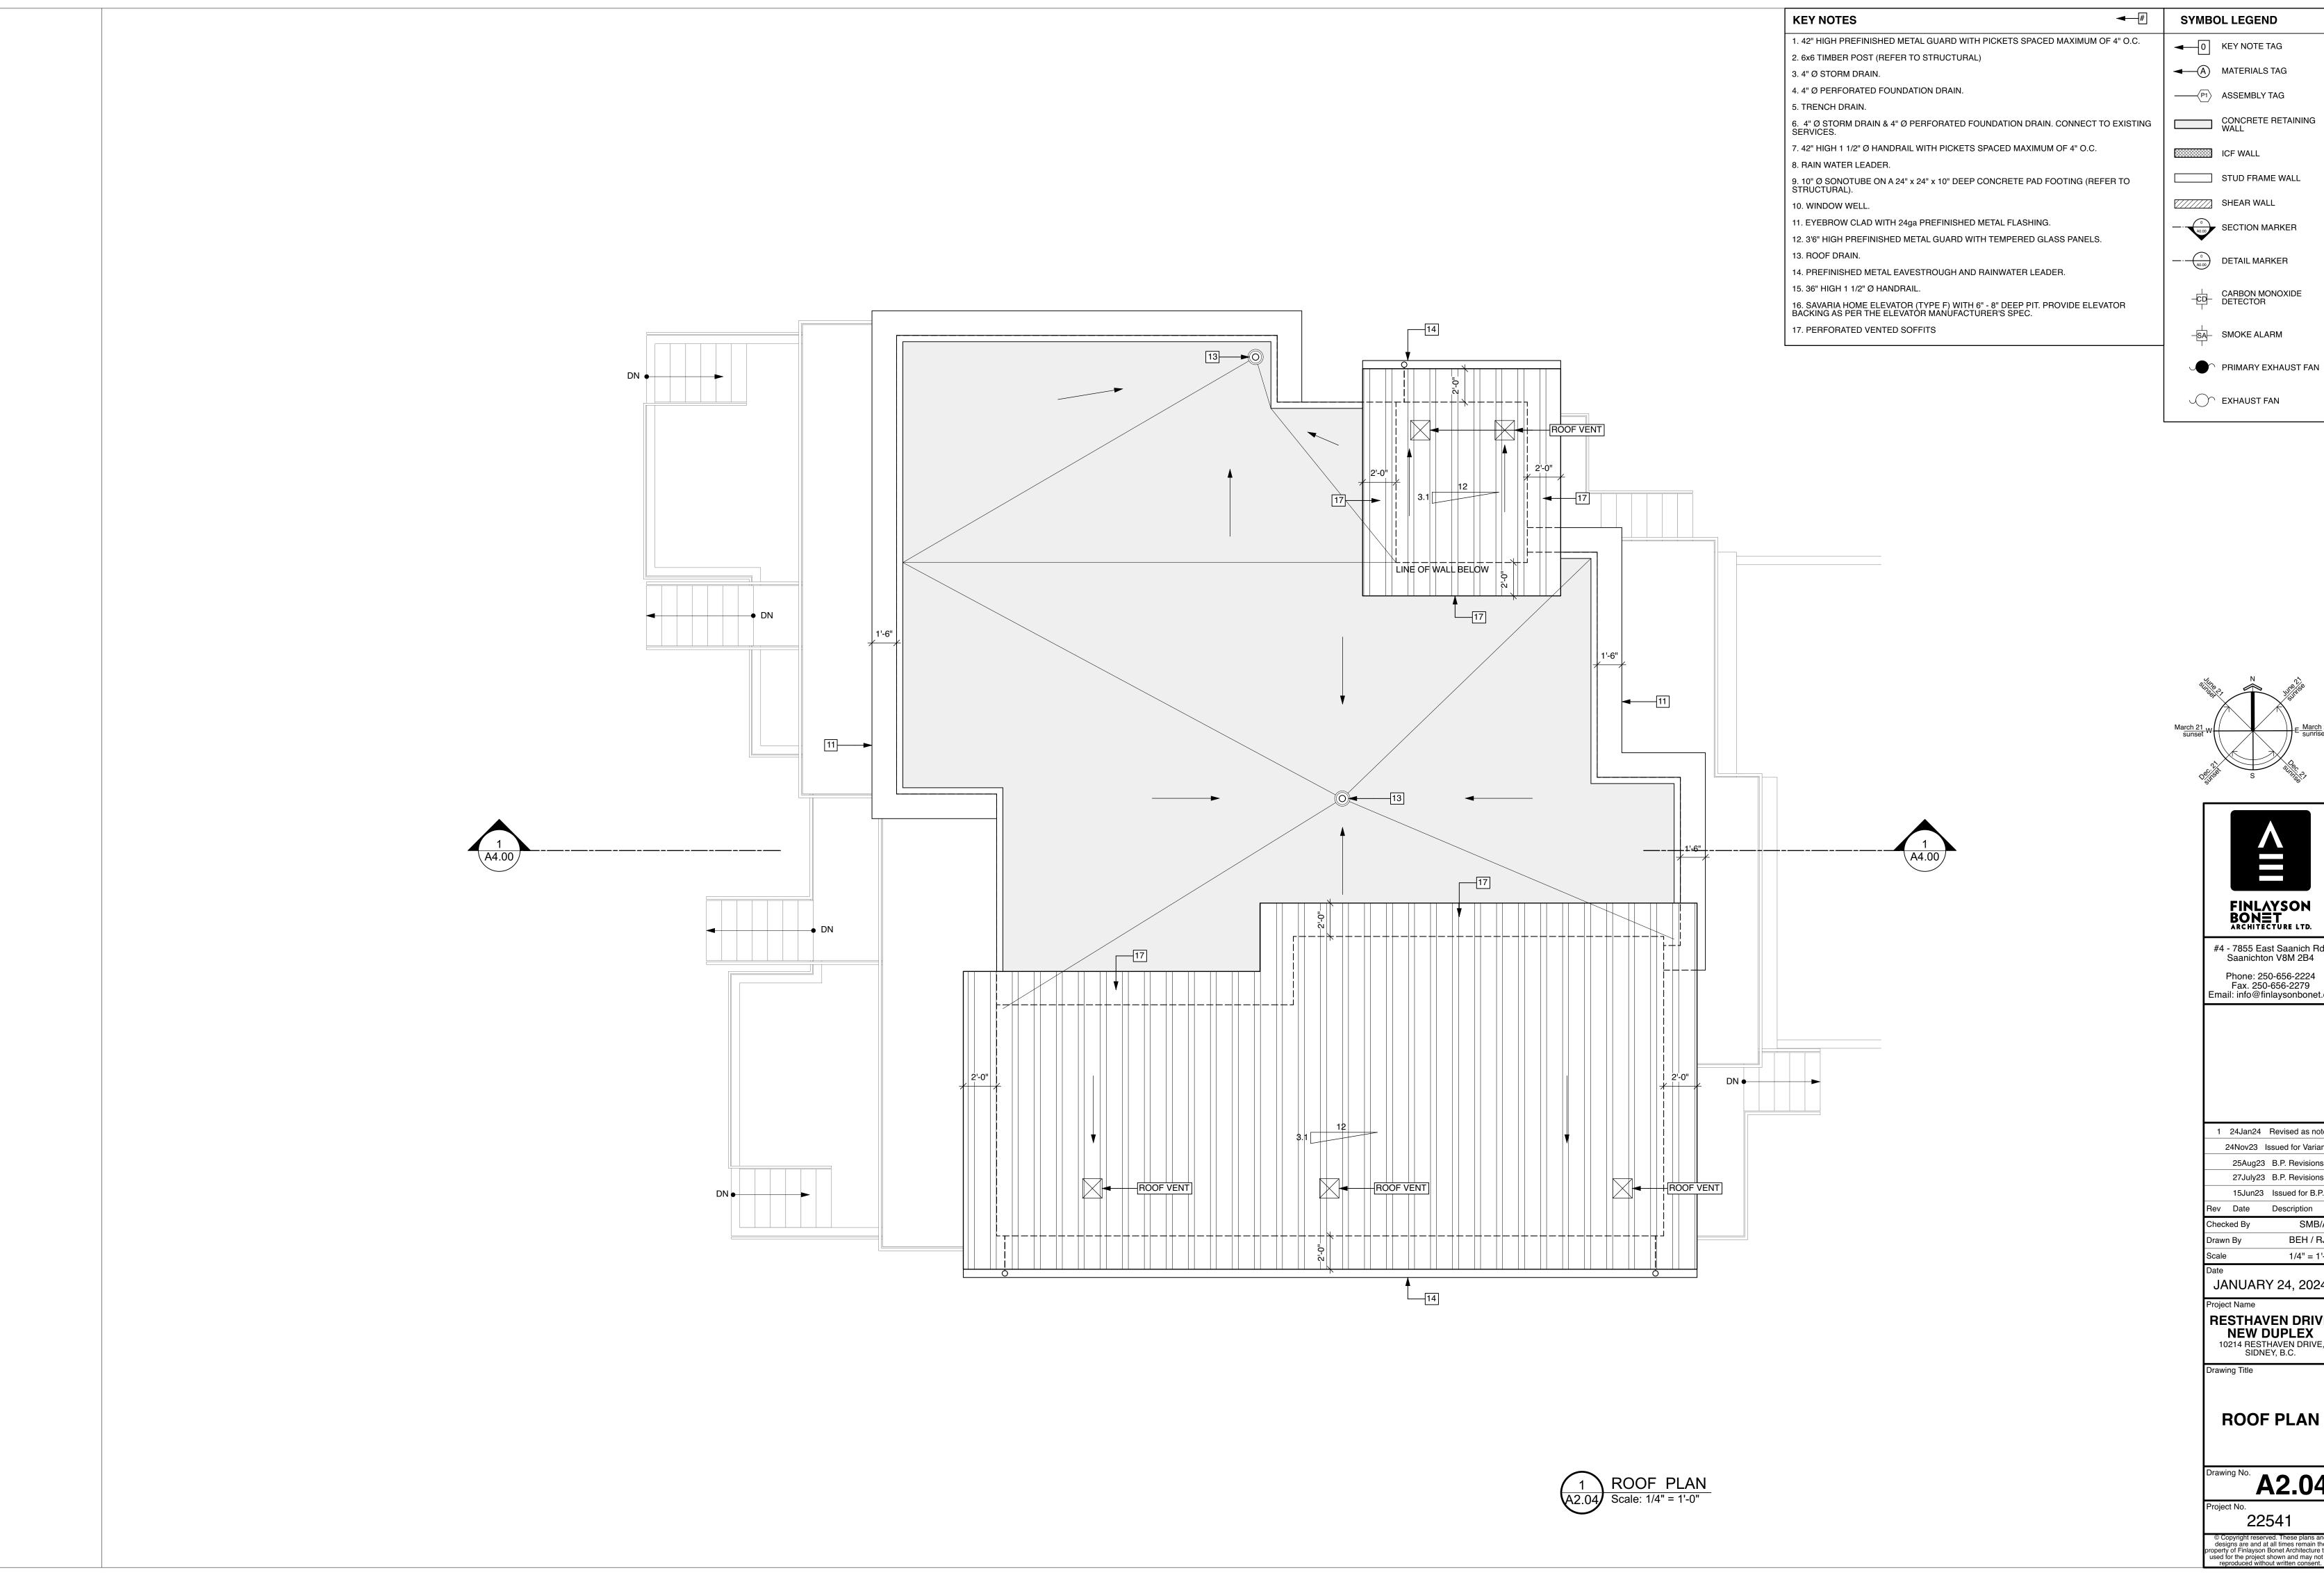
RESTHAVEN DRIVE NEW DUPLEX

10214 RESTHAVEN DRIVE, SIDNEY, B.C. Drawing Title


SECOND FLOOR PLAN

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SYMBOL LEGEND ■ 0 KEY NOTE TAG ■ MATERIALS TAG CONCRETE RETAINING WALL ICF WALL STUD FRAME WALL SHEAR WALL SECTION MARKER —— DETAIL MARKER CARBON MONOXIDE DETECTOR





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RESTHAVEN DRIVE NEW DUPLEX 10214 RESTHAVEN DRIVE, SIDNEY, B.C.

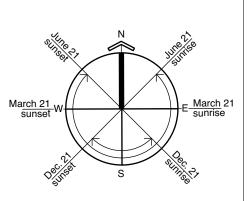ROOF PLAN

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ARCHITECTURE LTD.

•——A SYMBOL LEGEND

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RESTHAVEN DRIVE NEW DUPLEX 10214 RESTHAVEN DRIVE, SIDNEY, B.C.

A3.00

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