
SITE PLAN & PROJECT INFO

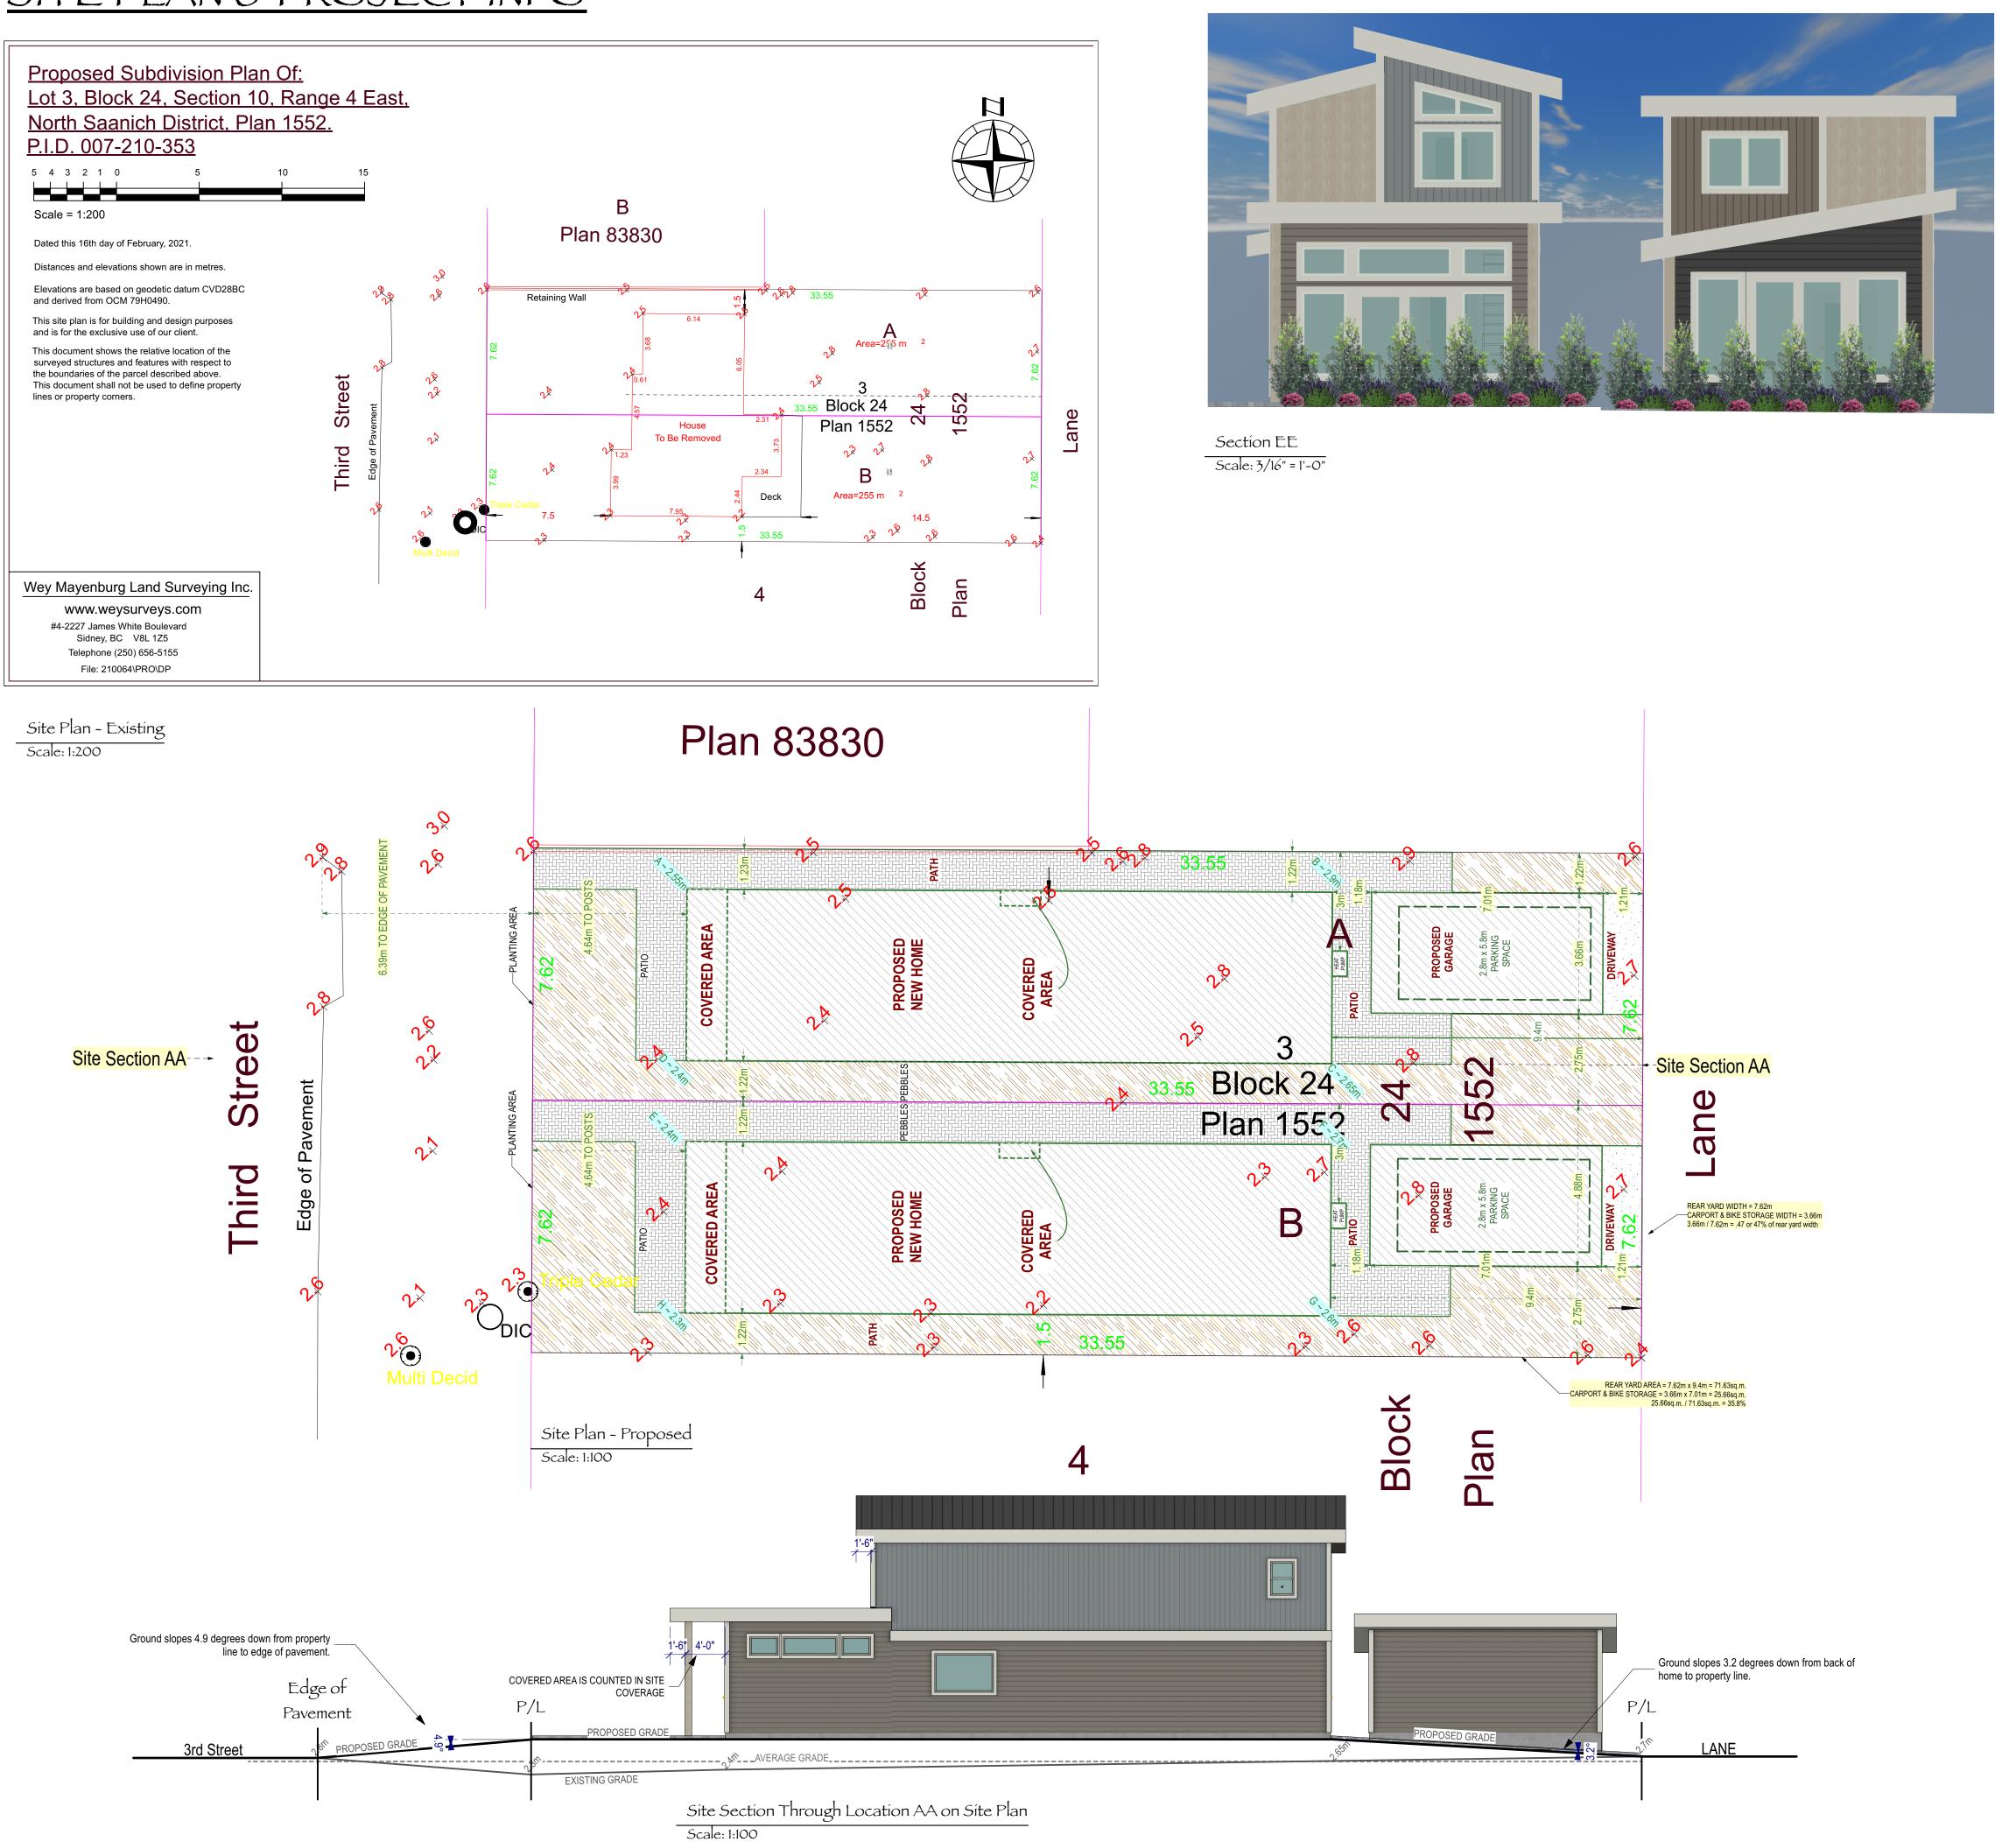

*** PLANS ARE FORMATTED TO BE PRINTED AT 36" X 24" ***

*** ENGINEERS' SPECIFICATIONS TO SUPERCEDE THESE PLANS AS REQUIRED ***

6933 3rd Street - Data Information Table - Proposed New Homes

Item	R1 - Neighbourhood Residential	Proposed Lot A (North)	Proposed Lot B (South)	
Permitted Uses Pertaining to this Application	Accessory Building, Single Family Dwelling, Secondary Suite, Home Occupation			ОК
Lot Area	Min. 250sq.m	255sq.m. (2744.8sq')	255sq.m. (2744.8sq')	ОК
Lot Width	Min. 7.5m	Lot Width is 7.62mm	Lot Width is 7.62mm	ОК
Lot Coverage	Max. 50%	Max. 50% 1363.8sq' = 49.7% (Including covered area on West side, Covered Entrance, and Carport)		ОК
Height (Natural grade at extreme four corners of building, to highest point)	Max. 10.5m (Roof pitch 3:12 or less) or Max. 12.0m (Roof pitch greater than 3:12)	8m	6.82m	ОК
Storeys	Max. 3 Storeys	2 Storeys	2 Storeys	ОК
Front Yard Setback	Min. 3.0m	4.64m to Posts	4.64m to Posts	ОК
Stairs Projecting into Front Yard Setback	Unenclosed stairs & landings are permitted in the front & rear setback	N/A	N/A	ОК
Rear Yard Setback	Min. 3.0m	9.4m	9.4m	ОК
Interior Setbacks	Min. 1.2m	1.22m Each Side	1.22m Each Side	ОК
Parking	Min. 1 space	1 Parking space	1 Parking space	ОК
Grade	Per Building Bylaw 3.6.6: No person shall alter or allow the alteration of the ground elevations of a site in a manner that adversely affects the drainage of adjoining properties.	Average natural grade around perimeter of building is 2.63m. Proposed finished grade around perimeter of building is 3.3m (0.67m above existing)	Average natural grade around perimeter of building is 2.5m. Proposed finished grade around perimeter of building is 3.17m (0.67 above existing)	Variance Requested

9633 3rd Street - Data Information Table - Proposed Garages						
Item	R1 Neighbourhood Residential	Proposed Lot A (North)	Proposed Lot B (South)			
Height	Max. 5.0m	~4.15m	~4.15m	ОК		
Setbacks	Min. 1.2m from any lot line	1.22m (North), 2.75m (South), 1.21m (East)	1.21m (North), 2.75m (South), 1.21m (East)	ОК		
Floor Area	Max. 25% Rear Yard	35.80%	35.80%	Variance Required		
		(Garage is 276sq' or 25.6sq.m. Rear Yard is 71.6sq.m.)	(Garage is 276sq' or 25.6sq.m. Rear Yard is 71.6sq.m.)			
Width	Max. 50% Rear Yard	47%	47%	ОК		

Natural Grad	e - North Lot	Natural Grad	e - South Lot
POINT	GRADE (m)	POINT	GRADE (m)
Α	2.55	E	2.40
В	2.90	F	2.70
С	2.65	G	2.60
D	2.40	Н	2.30
AVERAGE (m)	2.63	AVERAGE (m)	2.50

____ __

Cumming Design	Tara Cumming 250-889-4918 cumming.design@shaw.ca	DWG NO: A-1 DATE: 2024 Sep 13 10:52:22 AM
9633 3rd S Sídney,		DESIGN BY: Niall & Tara DRA WN BY: TARA



*** PLANS ARE FORMATTED TO BE PRINTED AT 36" X 24" ***

*** ENGINEERS' SPECIFICATIONS TO SUPERCEDE THESE PLANS AS REQUIRED ***


Front Right Scale: 3/32" = 1'-0"

			Spalla	I Separations		ations - North Lot		
	WALL	LIMITING DISTANCE (m)		EXPOSING BUILDING FACE (sq.m.)	PROPOSED UNPROTECT ED OPENINGS (sq.ft.)	ALLOWABLE UNPROTECT ED OPENINGS (%)	PROPOSED UNPROTECT ED OPENINGS (%)	Allowable mu be greater tha or equal to Proposed
	~From Site Plan & Elevations~	~From Site Plan~	~Finished Ground to uppermost Ceiling~	~This column auto-calculates~	~From Elevations~	~PER BCBC 9.10.14.4~	~This column auto-calculates~	~Compare Allowable to Proposed~
	North Elevation	1.22m	995	92	68.3	7.0%	6.9%	ок
	South Elevation	1.22m	1009.3	94	57.08	7.0%	5.7%	ОК
	24.	3sq'						
7sq'			7sq'					
					Fir	nished Grade around	Home: 3.3m Geodetic	
			AVERAGE GRADE		2.551			
		EXISTING GRADE			<u>V</u> ;			
8.75sq'								
	LEST							
	2651							
	2.651							
	2.651							
	2.6m							
	Len							
	2.631							
	Lenn							
	Lenn							
	Len							
	Lean							
							DWG NO:	2
						Cumming	DWG NO:	2
				ummíng Desig	S Tara (Cummíng B89-4918 lesígn@shaw.ca		

Rear Left Scale: 3/32" = 1'-0"


10:52:25 AM DESIGN BY: 9633 3rd Street Sídney, B.C. Niall & Tara DRA WN BY: TARA

Lot A (North Lot) FLOOR PLANS & SECTIONS

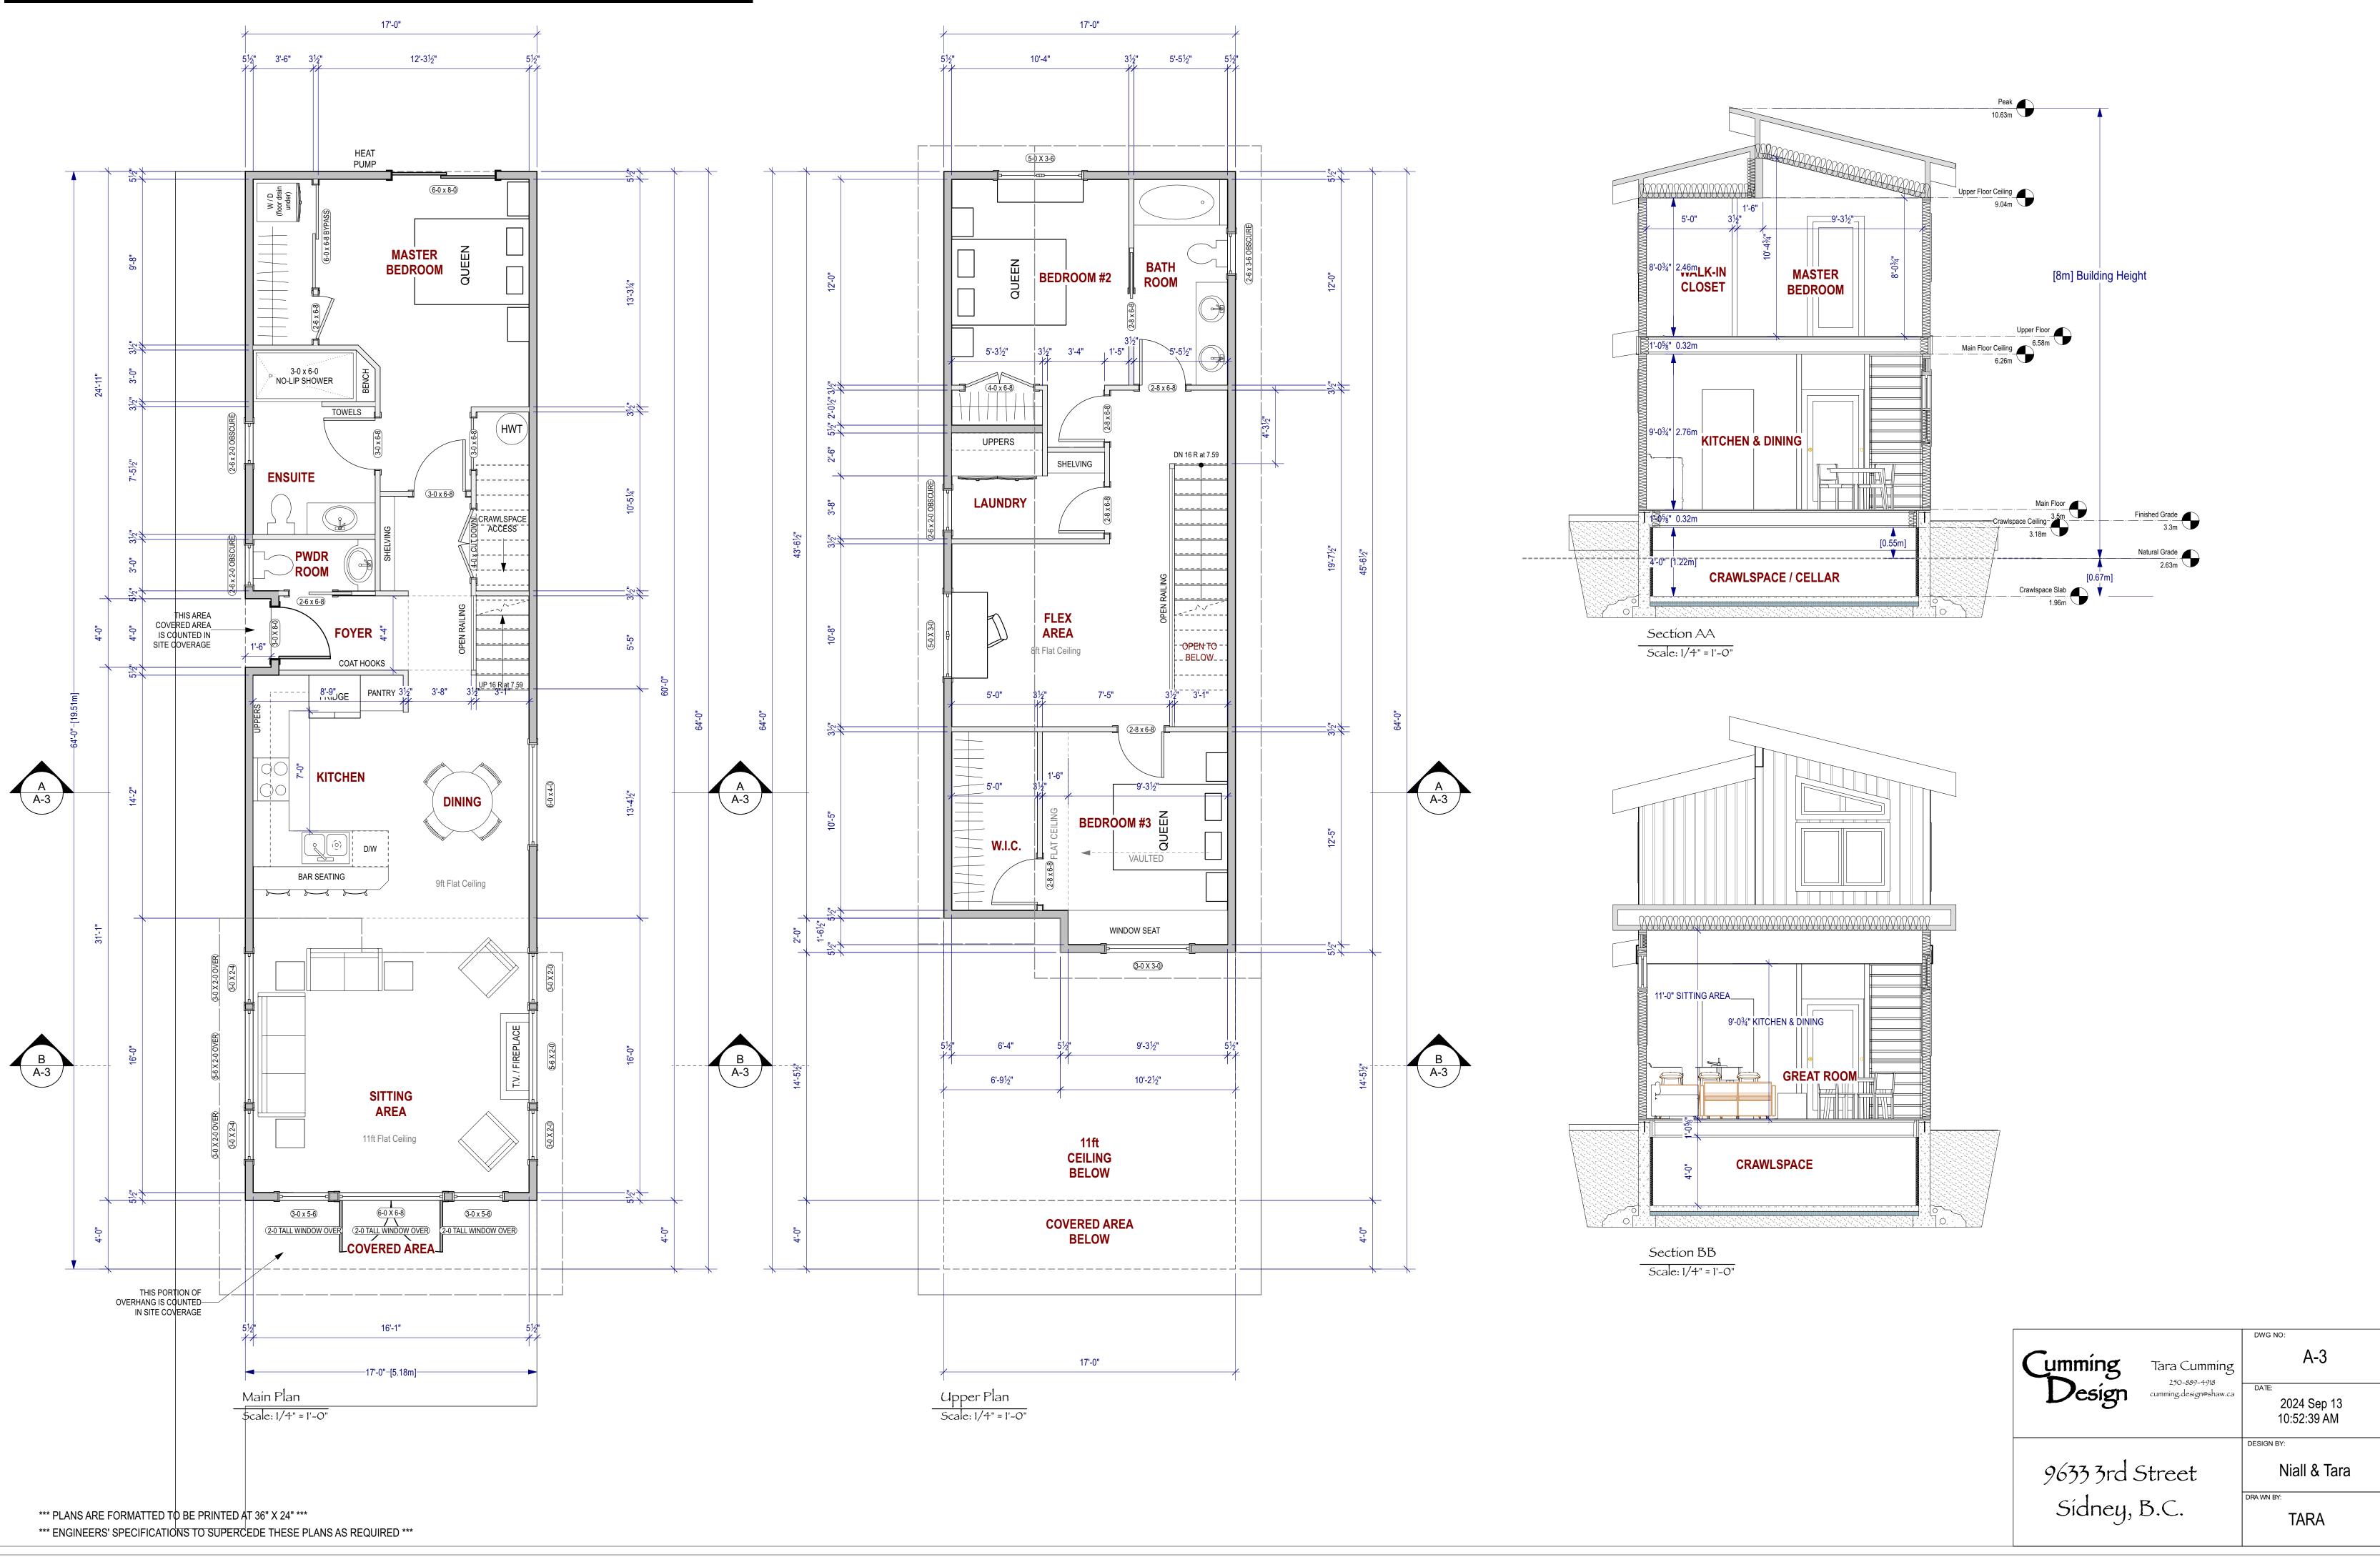



Lot B (South Lot) FLOOR PLANS & SECTIONS

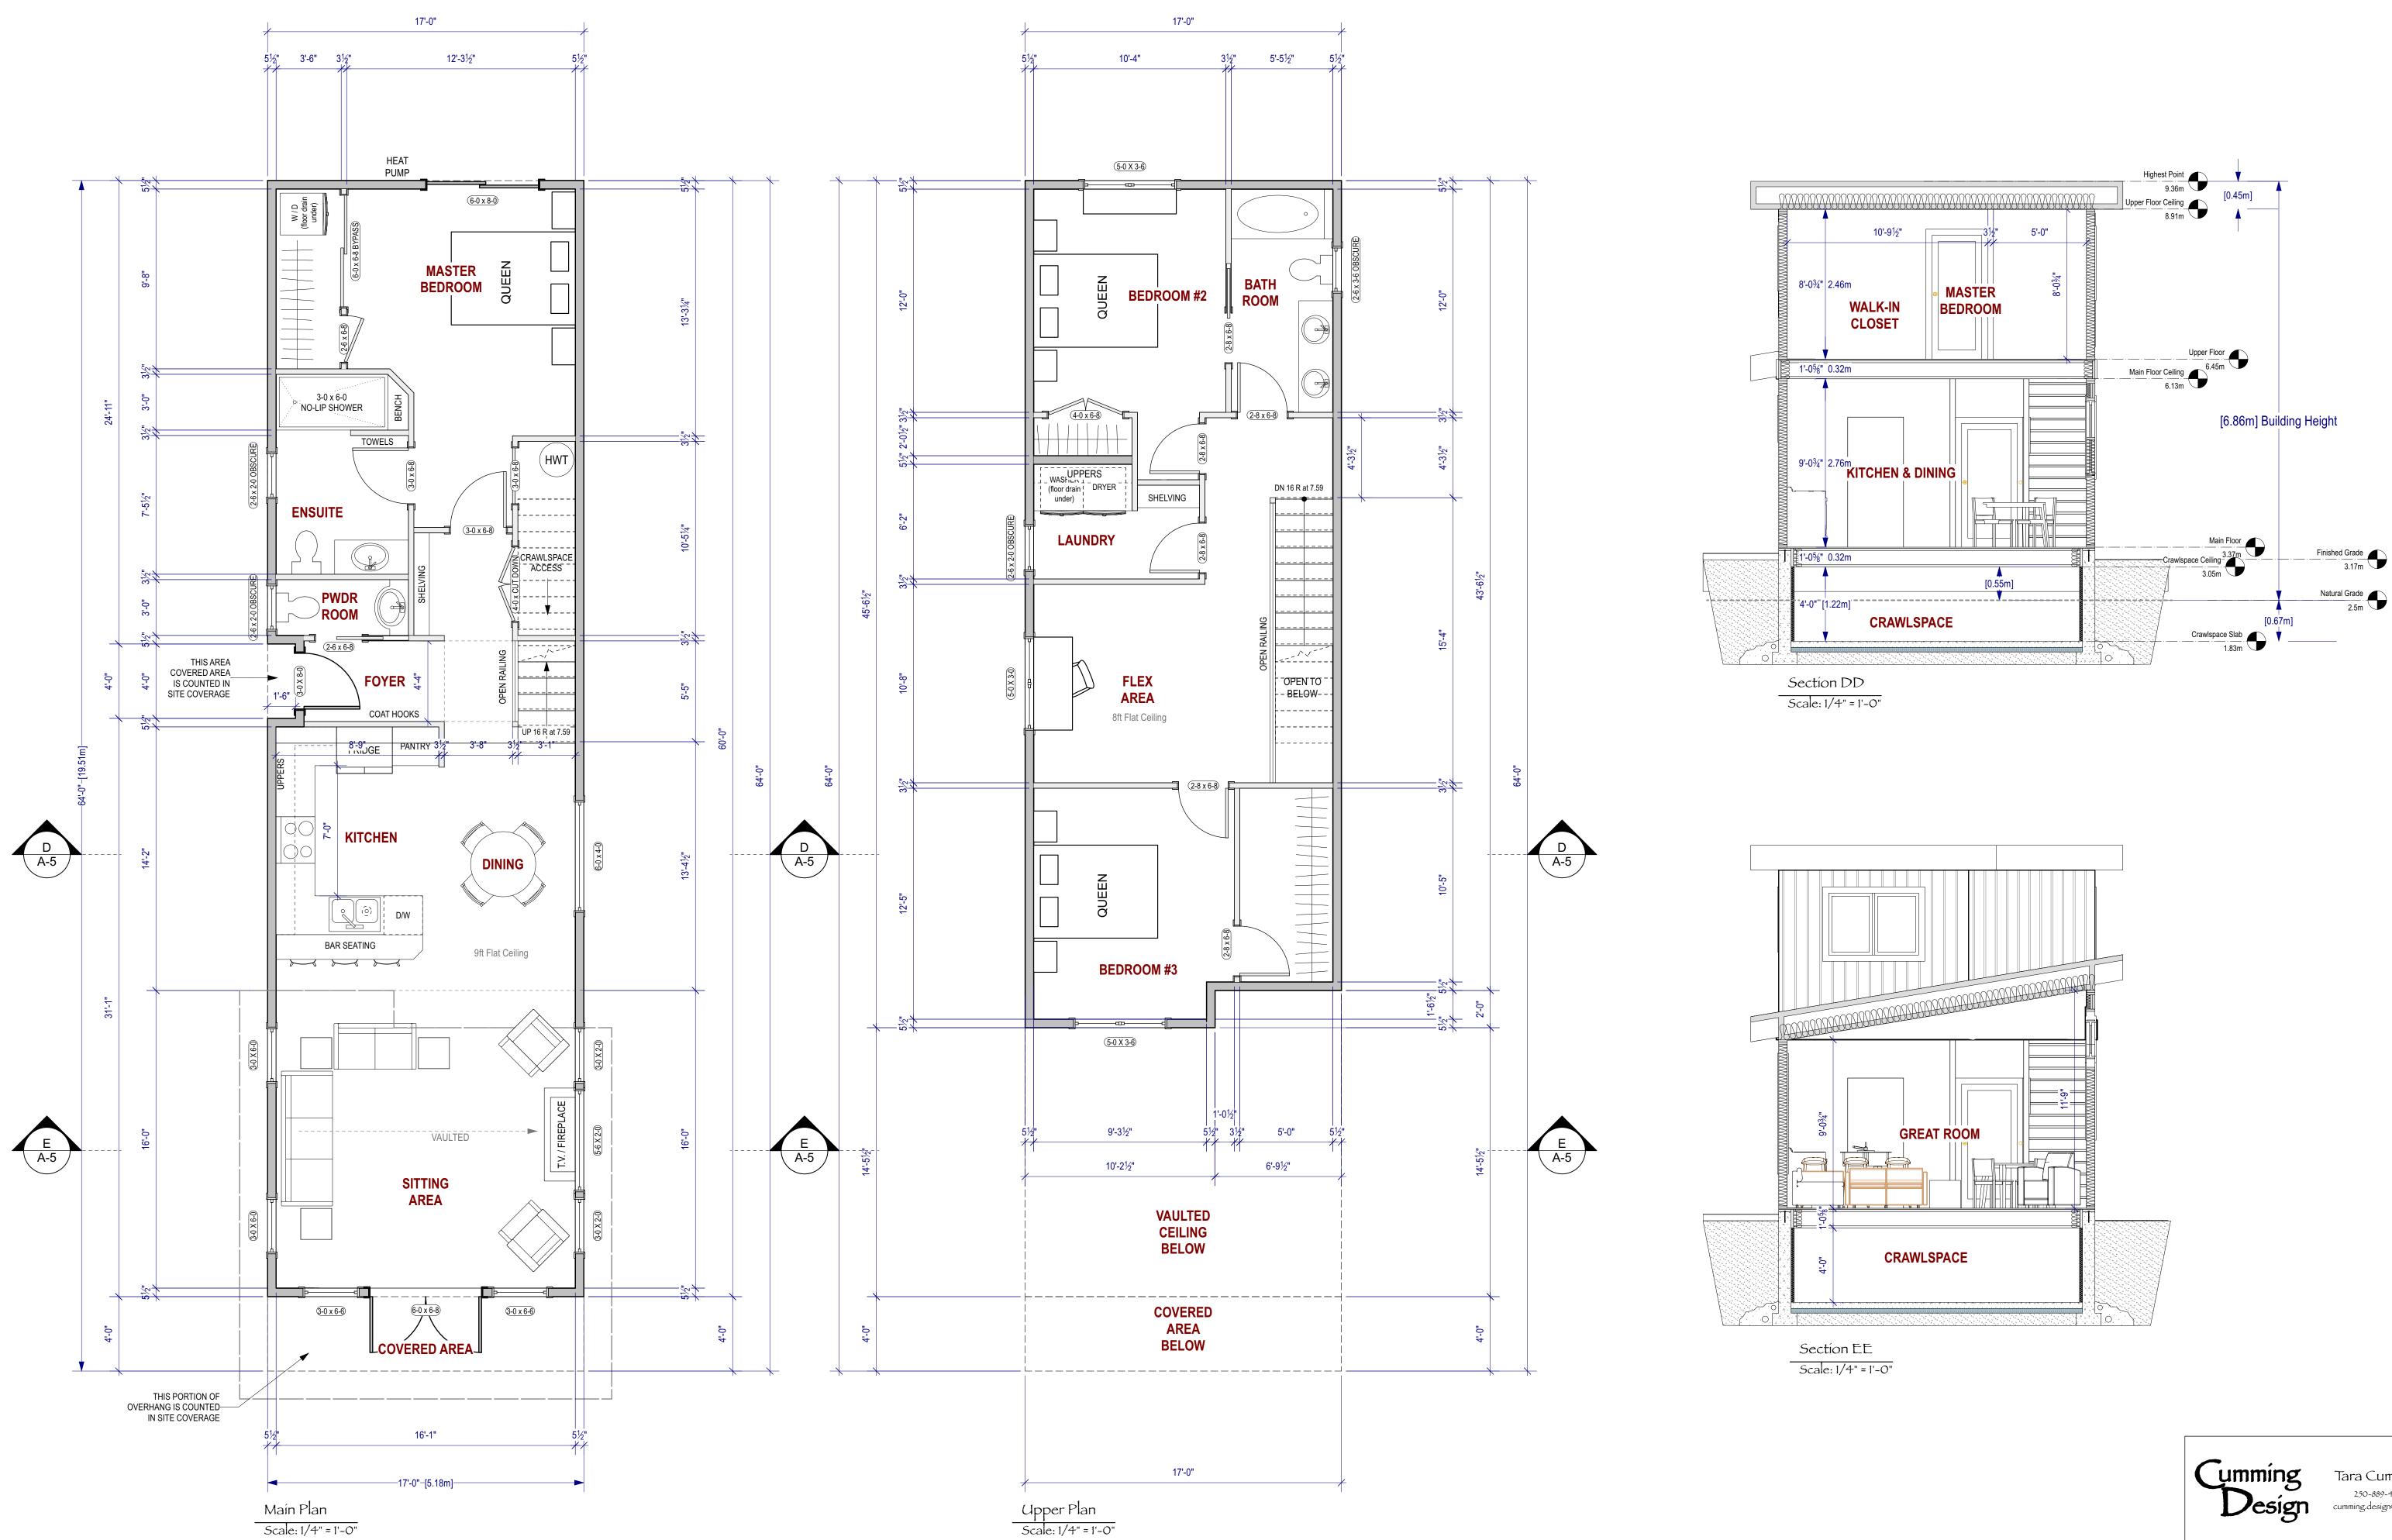



*** PLANS ARE FORMATTED TO BE PRINTED AT 36" X 24" ***

*** ENGINEERS' SPECIFICATIONS TO SUPERCEDE THESE PLANS AS REQUIRED ***



STREETSCAPE & COLOUR SWATCHES

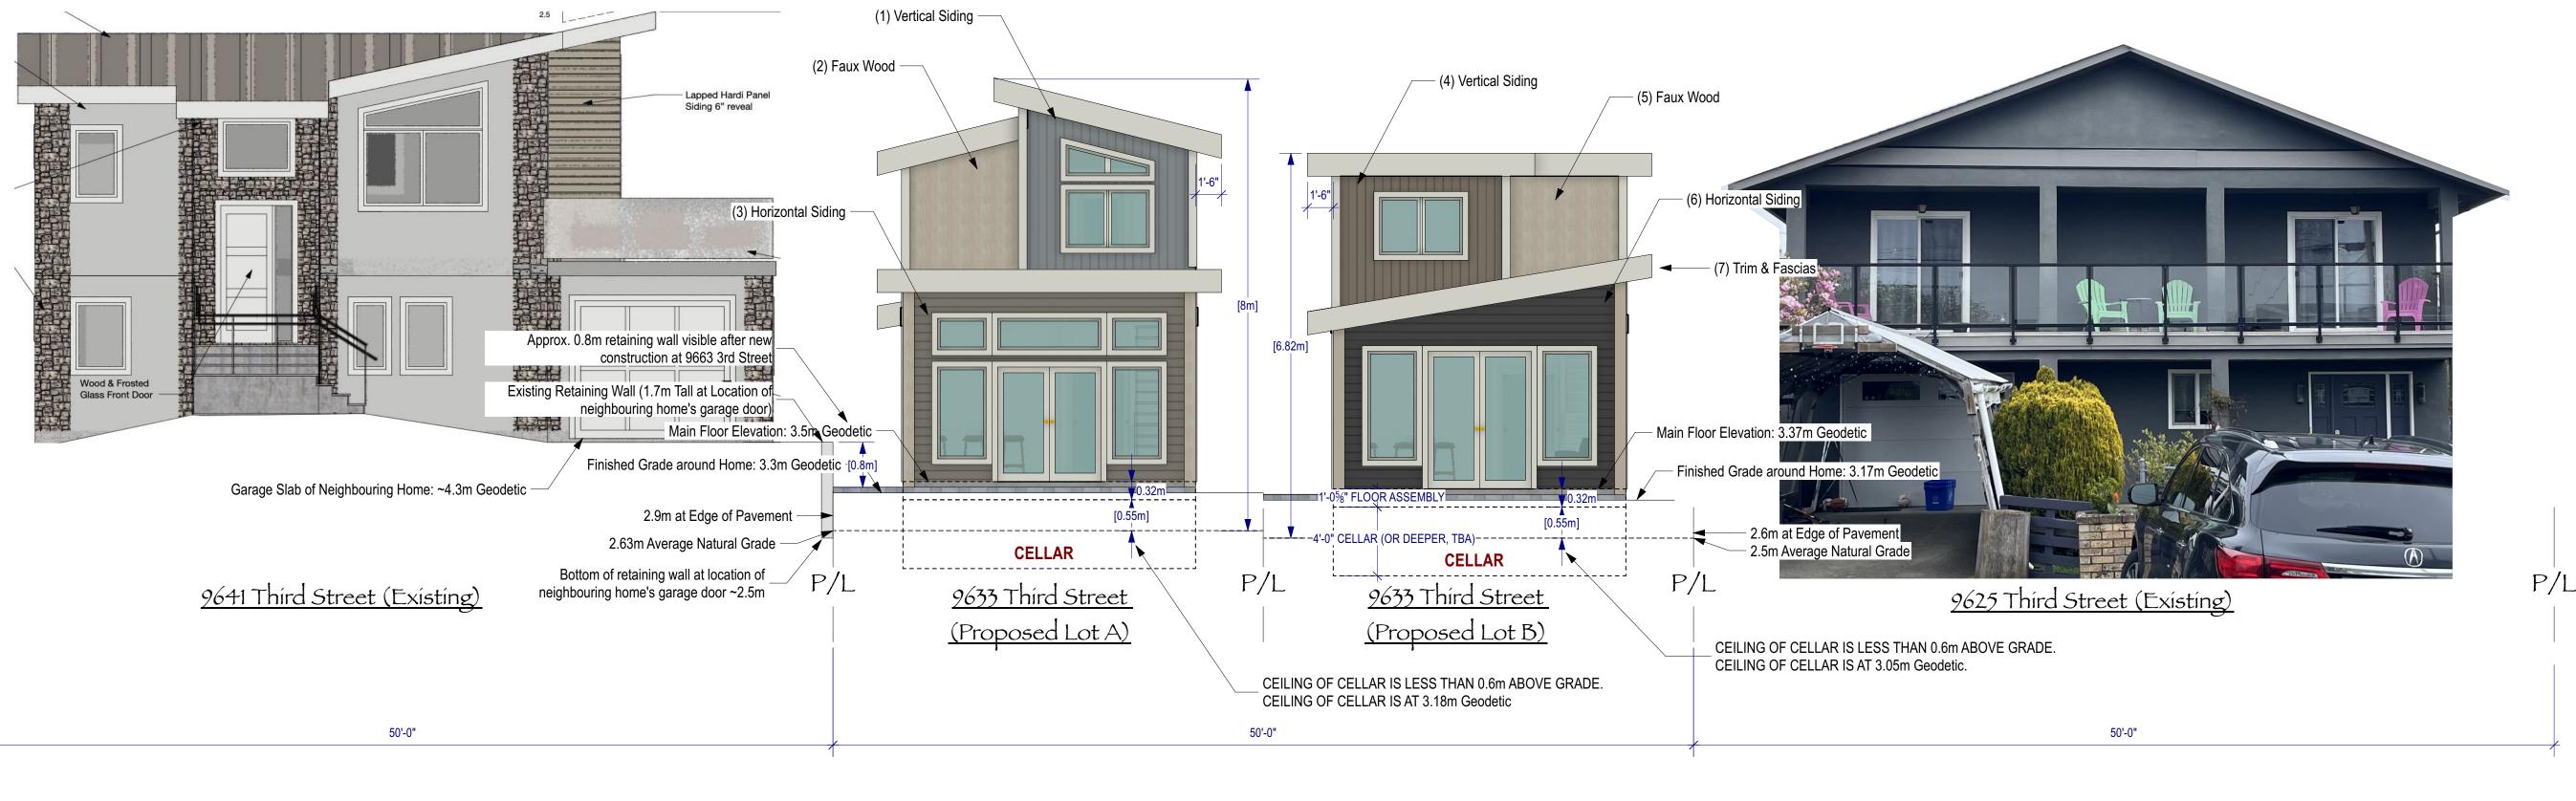

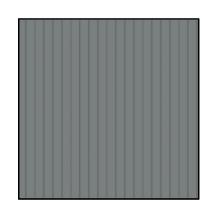


(1) Vertical Siding: Uncertain Gray (Sherwin Williams)




(2) Faux Wood: White Granite (Rustic Series Hardie)

P/L



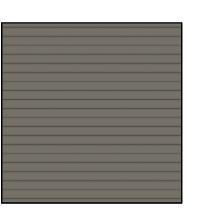

(3) Horizontal Siding: Rushing River (Sherwin Williams)

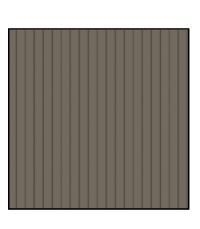


(4) Vertical Siding: Keystone Gray (Sherwin Williams)



(5) Faux Wood: Sand Castle (Rustic Series Hardie)




(6) Horizontal Siding: Peppercorn (Sherwin Williams)

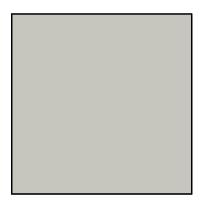

(7) Trim & Fascias: Modern White (Sherwin Williams)




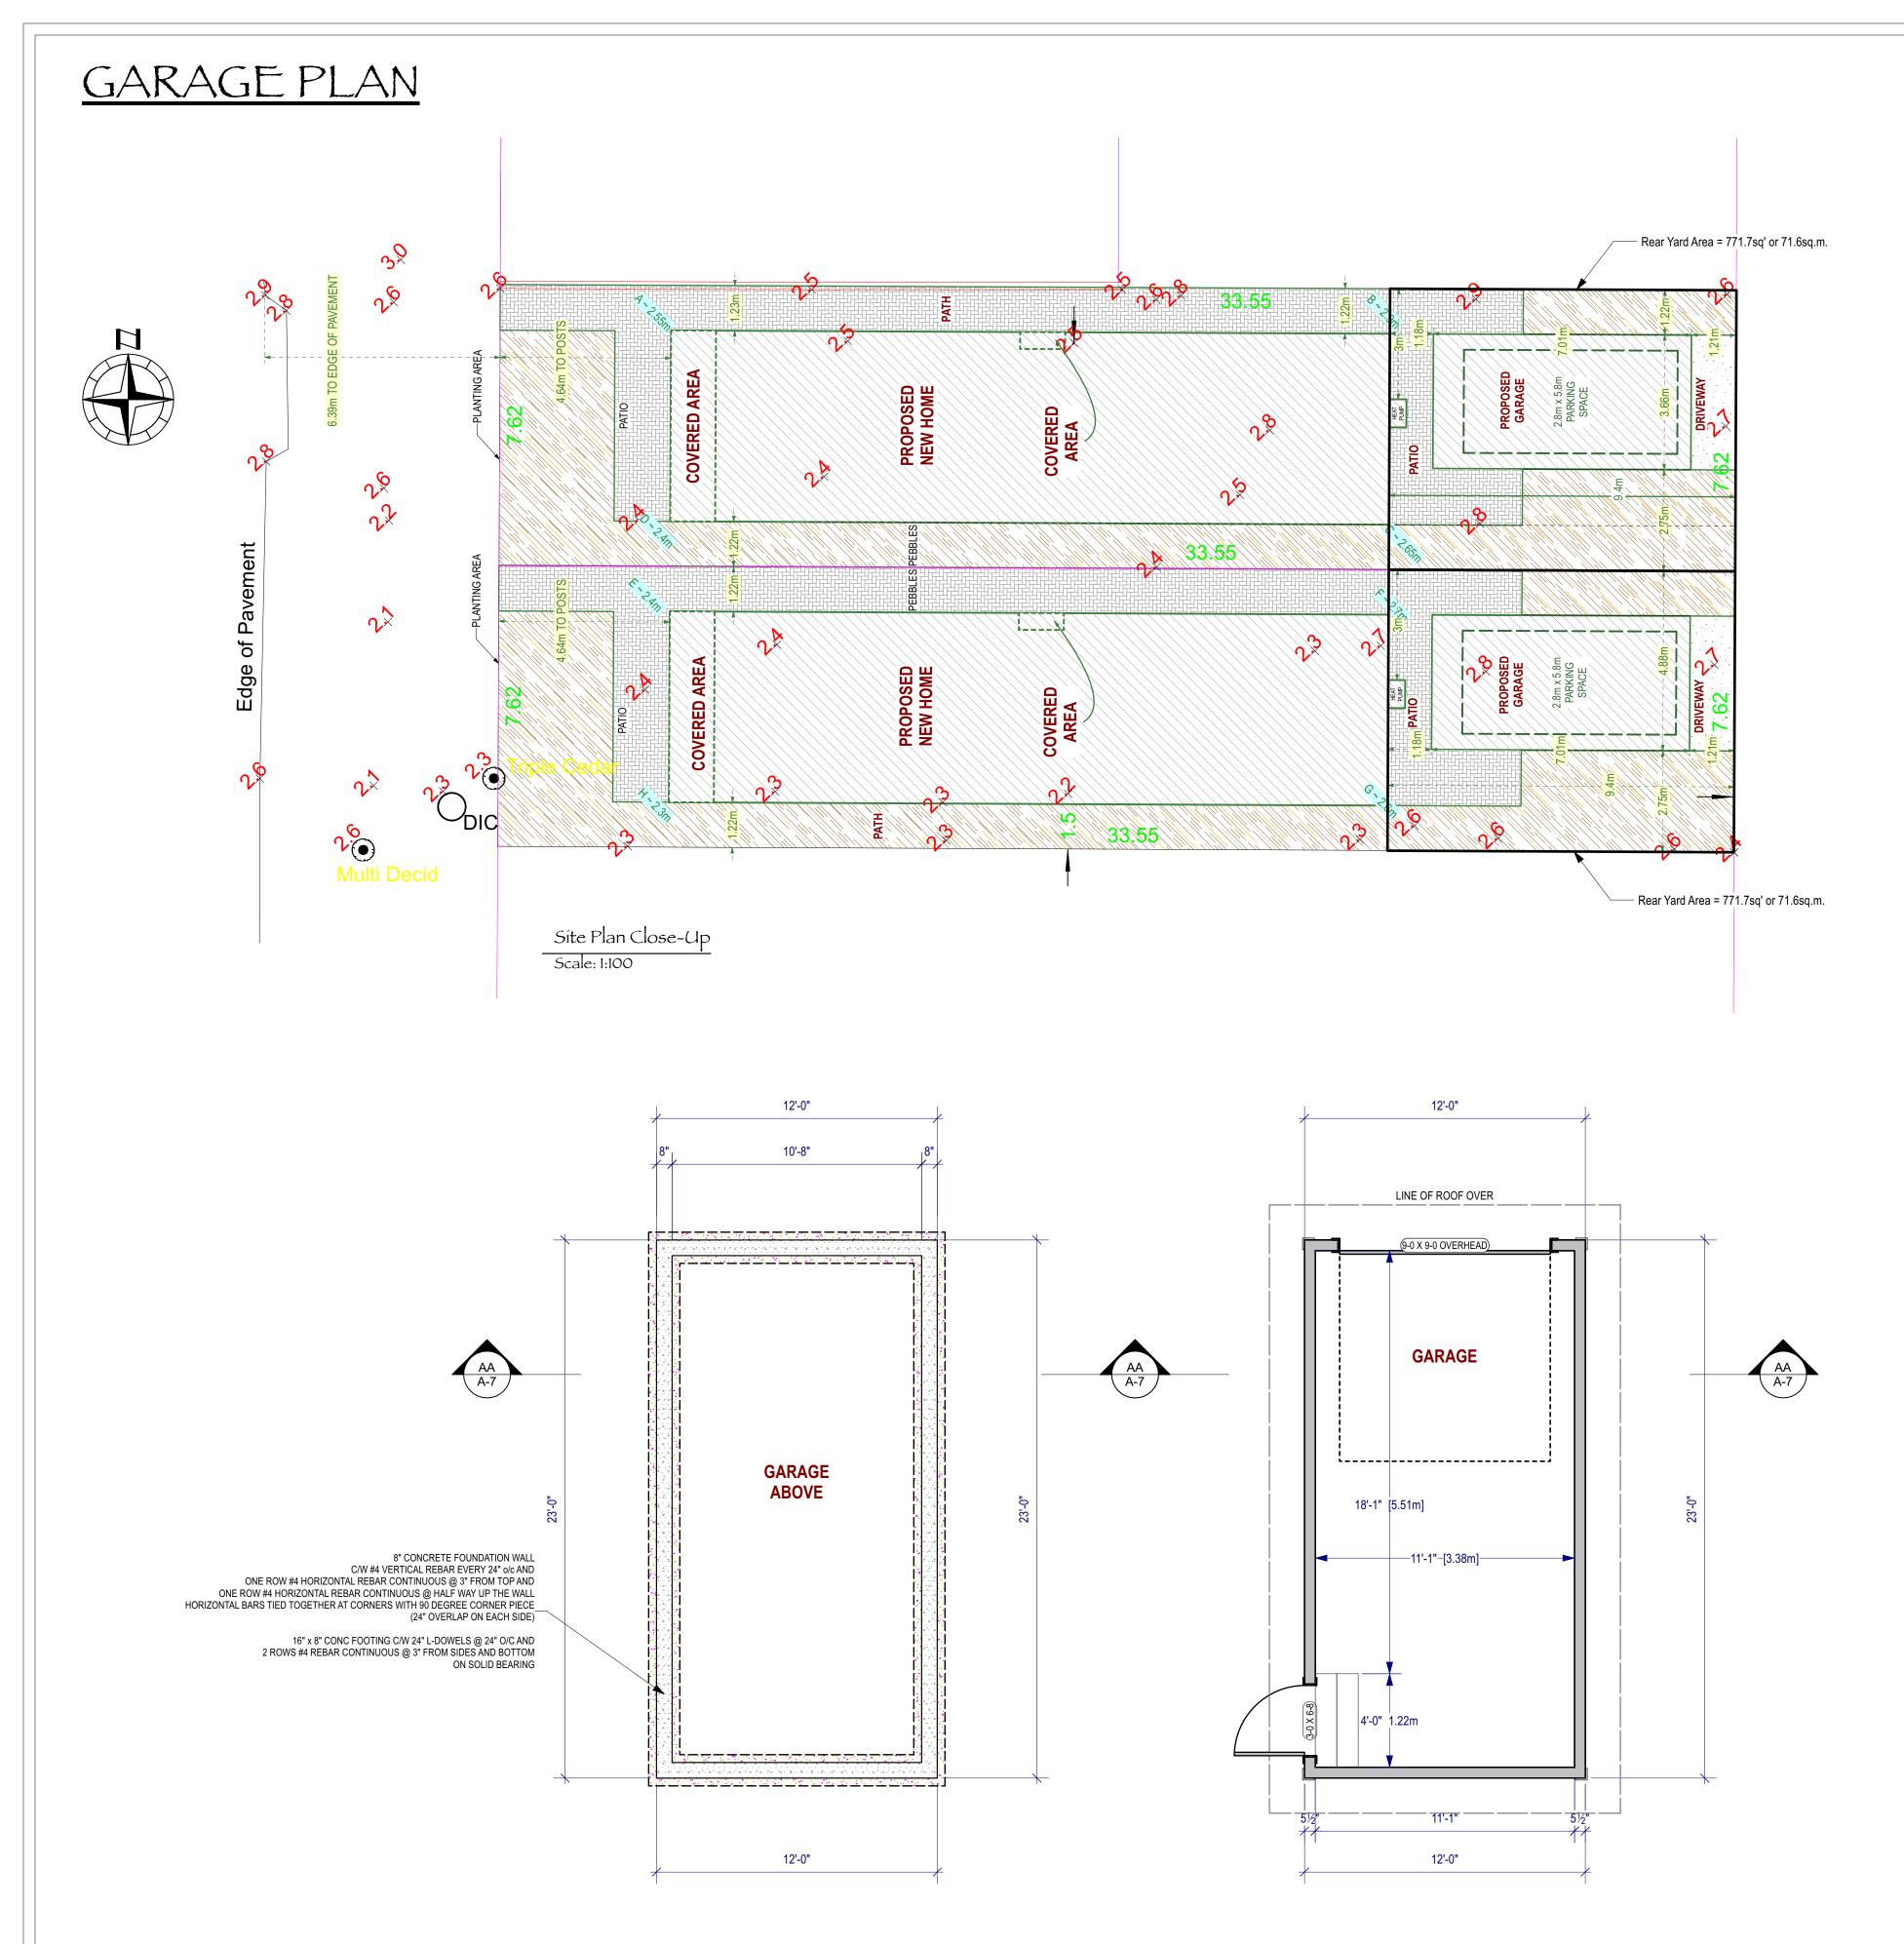

Carport Foundation Plan Scale: 1/4" = 1'-0"

*** PLANS ARE FORMATTED TO BE PRINTED AT 36" X 24" ***

*** ENGINEERS' SPECIFICATIONS TO SUPERCEDE THESE PLANS AS REQUIRED ***

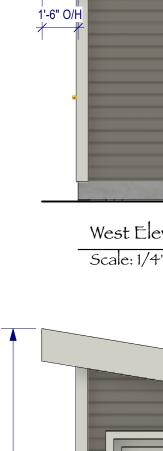


leight

Setbacks


Floor Area

Width



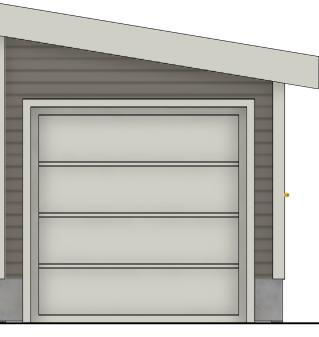

East Elevation (Facing Lane) Scale: 1/4" = 1'-0"

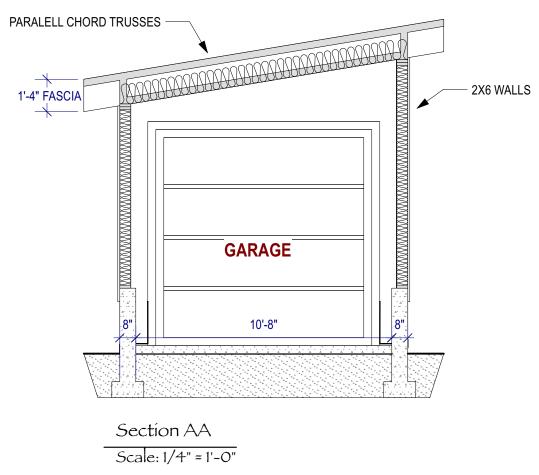

Carport Floor Plan Scale: 1/4" = 1'-0"

Item	R1 Neighbourhood Residential	Proposed Lot A (North)	Proposed Lot B (South)	
	Max. 5.0m	~4.15m	~4.15m	ОК
	Min. 1.2m from any lot line	1.22m (North), 2.75m (South), 1.21m (East)	1.21m (North), 2.75m (South), 1.21m (East)	ОК
	Max. 25% Rear Yard	35.80%	35.80%	Variance Required
		(Garage is 276sq' or 25.6sq.m. Rear Yard is 71.6sq.m.)	(Garage is 276sq' or 25.6sq.m. Rear Yard is 71.6sq.m.)	
	Max. 50% Rear Yard	47%	47%	ОК





West Elevation (Facing Home) Scale: 1/4" = 1'-0"

